
192 BROOKLINE ST. WORCESTER, MA 01603 SITE PLAN

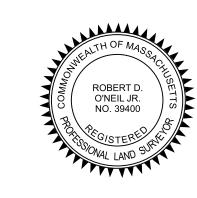

AND SURVEYING ROBERT D. O'NEIL P.L.S. 66 DRURY LANE

GRAHAM, P.E. SNOW DRIVE STFORD, MA 01886

PROFES

JOSEPH GRAHAM CIVIL NO. 53706 PORTERED

Coes Reservoir

LOCUS MAP 1"=400'

ZONING TABLE							
	MIN REQUIREMENTS						
DISTRICT	LOT AREA SQFT	LOT FRONTAGE	FRONT YARD	SIDE YARD	REAR YARD	ADD'L AREA PER DU	
RS-7	7,000	65	20	8	20	-	

APPLICANT:

OWNER/

ALI FADHEL

SITE ADDRESS:

192 BROOKLINE ST., WORCESTER, MA 01603

DRAWING LIST_

1 G1.0 COVERSHEET
2 G1.1 NOTES
3 V1.1 EXISTING CONDITIONS

4 C1.1 SITE LAYOUT
5 C2.1 GRADING PLAN
6 C3.1 UTILITY PLAN
7 LD1.1 LANDSCAPING PLAN

9 C5.1 CONST. DETAIL SHEET 1 OF 3 10 C5.2 CONST. DETAIL SHEET 2 OF 3 11 C5.3 CONST. DETAIL SHEET 3 OF 3

C4.1 EROSION CONTROL PLAN

•	ALL WORK TO CONFORM TO CITY OF WORCESTER STANDARDS.
•	ALL FLEVATIONS AND RENCHMARKS REFER TO NAD-83 DATUM

ALL ELEVATIONS AND BENCHMARKS REFER TO NAD-85 DATUM.
 THE APPLICANT WILL PROVIDE, AT NO COST TO THE CITY, ALL FACILITIES SHOWN ON THE PLAN INCLUDING BUT NOT LIMITED TO ROADWAYS, CURBS, BOUND, DRAINAGE SYSTEMS, SANITARY SEWER SYSTEMS, UTILITIES, STREET LIGHTS, AND EARTHWORKS EXCEPT AS OTHERWISE NOTED.

11/18/24	PLANNING BOARD	1
10/17/24	CONSERVATION COMMISSION	0

4192

- 1. PROPERTY LINES & TOPOGRAPHIC SURVEY REVIEWED BY ROBERT D. O'NEIL JR., R.P.L.S. 66 DRURY LANE, WORCESTER, MASSACHUSETTS, 01609
- 2. PROPOSED GRADING/ DESIGN REVIEW BY JOSEPH GRAHAM, PE, 13 SNOW DRIVE WESTFORD, MA 01886.
- 3. ALL CONSTRUCTION MATERIALS & STANDARDS SHALL CONFORM TO THE CITY OF WORCESTER STANDARD SPECIFICATIONS. FOR ADDITIONAL DESIGN DETAILS CONSULT THE CITY OF WORCESTER'S "CONSTRUCTION DETAIL MANUAL" AS PREPARED BY THE DEPARTMENT OF PUBLIC WORKS.
- 4. ANY OR ALL PROPOSED UTILITY CONNECTIONS (i.e. SEWER & WATER) TO BE INSTALLED PER CITY OF WORCESTER STANDARDS.
- 5. ANY CHANGES OR AMENDMENTS TO THIS PLAN WILL REQUIRE APPROVAL FROM JOSEPH GRAHAM (THE ENGINEER).
- 6. SEVENTY TWO HOURS PRIOR TO COMMENCING ANY EXCAVATION, THE CONTRACTOR SHALL NOTIFY DIGSAFE AT (888) 344-7233. THE CONTRACTOR SHALL COORDINATE INSTALLATION OF NEW UTILITIES WITHIN IN THE VICINITY OF EXISTING UTILITIES. (UNDERGROUND AND OVERHEAD) WITH THE APPROPRIATE UTILITY PROVIDER.
- 7. THE CONTRACTOR SHALL RECORD AND PROVIDE THE OWNER WITH AS-BUILT LOCATIONS OF ALL UTILITIES INSTALLED AS PART OF HIS/HER WORK, INCLUDING UTILITIES NOT INDICATED ON THE PLAN (I.E. GAS, CABLE, TV TELEPHONE, ELECTRIC, ETC.) IF APPLICABLE.
- 8. THE CONTRACTOR SHALL BE RESPONSIBLE TO LAY OUT THE CONSTRUCTION AS SHOWN ON PLAN.
- 9. THE CONTRACTOR SHALL BE RESPONSIBLE TO ENSURE THAT THE PROPOSED CONSTRUCTION ACTIVITIES DO NOT DAMAGE OR UNDERMINE EXISTING SLOPES, BUILDINGS, WALLS, STRUCTURES, ETC. IN THE AREA AROUND THE CONSTRUCTION. REPAIR OF EXISTING SLOPES, BUILDINGS, WALLS, STRUCTURES, ETC. THAT ARE DAMAGED OR UNDERMINED BY THE CONTRACTORS WORK SHALL BE THE RESPONSIBILITY OF THE CONTRACTOR.
- 10. EXISTING UTILITIES WERE LOCATED AS PART OF THIS PLAN AND ARE TO BE FIELD UTILITY LOCATIONS AND ENSURING THAT THE PROPOSED WORK DOES NOT CONFLICT WITH THE EXISTING UTILITY NOT SHOWN. ALL REQUIRED PERMITS SHALL BE SECURED PRIOR TO COMMENCING WORK. PRIOR TO COMMENCING ANY WORK ONSITE THE CONTRACTOR SHALL NOTIFY THE CITY OF WORCESTER DEPARTMENT OF PUBLIC WORKS.
- 11. SUITABLE FILL SHALL CONSIST OF MATERIAL FREE OF ORGANIC MATERIALS, LOAM, AND ANY DELETERIOUS MATERIAL. FILL SHALL NOT CONTAIN STONES LARGER THAN 10" IN ANY DIMENSION, AND SHALL HAVE LESS THAN 75% PASSING THE NO. 4 SIEVE AND A MAXIMUM OF 20% PASSING THE NO. 200 SIEVE. SUITABLE FILL SHALL NOT CONTAIN ANY BUILDING RUBBLE, GRANITE OR CONCRETE BLOCK, ROOFING MATERIALS, OR OTHER CONSTRUCTION REFUSE. AT THE TIME OF PLACEMENT SUITABLE FILL SHALL NOT CONTAIN FROST, SNOW, OR ICE AND SHALL NOT CONTAIN WATER GREATER THAN THE OPTIMAL MOISTURE CONTENT.
- 12. INVERT ELEVATIONS INDICATED AT THE BUILDING/FOUNDATION SHOULD BE COORDINATED BETWEEN THE SITE PLAN AND THE PLUMBING CONTRACTOR.
- 13. EXTERIOR FIXTURES SHALL BE DARK-SKY COMPLIANT AND/OR SHIELDED TO MINIMIZE SPILLOVER AND BE OF A WARMER TEMPERATURE (3,000K OR LESS).
- 14. PROVIDED THAT THE PROJECT IS CONSTRUCTED AND OPERATED IN SUBSTANTIAL ACCORDANCE WITH FINAL REVISED PLANS, INCLUDING ARCHITECTURAL RENDERINGS, CALCULATIONS, AND OPERATION AND MAINTENANCE AND SCHEDULES, ON FILE WITH THE CITY OF WORCESTER AND IN ACCORDANCE WITH ALL APPLICABLE GOVERNMENTAL CODES.

DIGSAFE:

15. EXCEPT FOR VISIBLE STRUCTURES (MANHOLES, GATES, POLES, ETC.) LOCATED BY ROBERT D. O'NEIL JR., R.P.L.S. ALL UNDERGROUND UTILITIES SHOWN WERE COMPLIED ACCORDING TO AVAILABLE RECORD PLANS FOR THE VARIOUS UTILITY COMPANIES AND PUBLIC AGENCIES AND ARE APPROXIMATE ONLY. ACTUAL LOCATIONS MUST BE DETERMINED I THE FIELD BEFORE DESIGNING, EXCAVATING, BLASTING, OR INSTALLING, BACKFILLING, GRADING, PAVEMENT RESTORATION, OR REPAIRING. ALL UTILITY COMPANIES, PUBLIC AND PRIVATE, MUST BE CONTACTED, INCLUDING THOSE IN CONTROL OF UTILITIES NOT SHOWN ON THIS PLAN. NOT RESPONSIBLE FOR DAMAGES INCURRED AS A RESULT OF UTILITIES OMITTED OR INACCURATELY SHOWN. THE CONTRACTOR IS TO CONTACT "DIGSAFE" @ 1-888-344.7233 PRIOR TO ANY CONSTRUCTION.

		EXISTING	PROPOSED	DESCRIPTION
		JB	JB	
16.	ALL WORK SHALL CONFORM TO THE CITY OF WORCESTER'S ZONING ORDINANCE, PLANNING BOARD DECISION AND CONDITIONS OF APPROVAL, AND THE STANDARDS	СВ	СВ	JERSEY BARRIER ON BRIDGE OR JERSEY BARRIER CATCH BASIN
	CONTAINED IN THE CITY OF WORCESTER, DEPARTMENT OF PUBLIC WORKS & PARKS, ENGINEERING DIVISION, CONSTRUCTION MANAGEMENT SECTION, STANDARD			CATCH BASIN CURB INLET
	SPECIFICATIONS & DETAILS, MOST RECENT EDITION.	FP	FP	FLAG POLE
	<u>Breathanta & Defrites</u> , Most Receive Edition.	GP	GP	GAS PUMP
17.	ALL TREE AND STUMP REMOVAL SHALL BE IN ACCORDANCE WITH THE ASIAN	MB	MB	MAIL BOX
	LONGHORNED BEETLE PROGRAM REQUIREMENTS AND ALL NEW TREES AND SHRUB			POST SQUARE
	PLANTINGS SHALL BE ASIAN LONHORNED BEETLE RESISTANT.	\\/	\A/E1.1	POST CIRCULAR
18	NO ROCK CRUSHING OR GRINDING OPERATIONS SHALL BE PERMITTED ONSITE AND	WELL	WELL	WELL
10.	THE CONTRACTOR SHALL TAKE STEPS TO LIMIT UNNECESSARY NOISE AND COMPLY	EHH	EHH	ELECTRIC HANDHOLE
	WITH THE CITY OF WORCESTER'S GENERAL REVISED ORDINANCE RELATIVE TO		0.0	FENCE GATE POST
	NOISE CONTROL.	GG	GG OR	GAS GATE
1.0		0		SIGN
19.	A PRE-CONSTRUCTION CONFERENCE WITH THE CITY OF WORCESTER'S DEPARTMENT OF PUBLIC WORKS & PARKS' DIVISION OF ENGINEERING SHALL BE HELD PRIOR TO	BHL #	BHL#	BORING HOLE
	ANY CONSTRUCTION.	MW #	MW #	MONITORING WELL
	That construction.	TP #	TP#	TEST PIT
20.	SUBJECT TO THE ZONING ENFORCEMENT OFFICER'S DETERMINATION THAT THE			HYDRANT
	PARCELS COMPLY WITH ALL THE RELEVANT PROVISIONS OF THE ZONING			LIGHT POLE
	ORDINANCE.	CO.BD.		COUNTY BOUND
21	THE CONTRACTOR SHALL TAKE ALL NECESSARY STEPS TO CONTROL DUST DURING			GPS POINT
21.	CONSTRUCTION BY UTILIZING A WATERING SYSTEM AND EMPLOYING THE USAGE			CABLE MANHOLE
	OF OTHER DUST SUPPRESSANT METHODS SUCH AS CHLORIDE SALTS (CALCIUM OF			DRAINAGE MANHOLE
	MAGNESIUM CHLORIDE).			ELECTRIC MANHOLE
22				GAS MANHOLE
22.	CONSTRUCTION OPERATIONS SHALL BE LIMITED FROM MONDAY TO SATURDAY BETWEEN THE HOURS OF 7AM TO 7PM. THERE SHALL BE NO WORK ON SUNDAYS OR			MISC MANHOLE
	HOLIDAYS.			SEWER MANHOLE
				TELEPHONE MANHOLE
23.	ALL CONSTRUCTION EQUIPMENT SHALL BE WELL MAINTAINED AND HAVE	MHB	MUD	WATER MANHOLE
	FUNCTIONING MUFFLERS AND SHALL COMPLY WITH THE DEPARTMENT OF	MON	MHB	MASSACHUSETTS HIGHWAY BOUND
	ENVIRONMENTAL PROTECTIONS ANTI-IDLING REGULATIONS TO PREVENT UNNECESSARY NOISE AND AIR POLLUTION WHILE NOT IN PRODUCTIVE USE.	SB		MONUMENT
	UNNECESSARY NOISE AND AIR POLLUTION WHILE NOT IN PRODUCTIVE USE.	TB		STONE BOUND
24.	TO MITIGATE DUST ON THE WORK SITE, THE CONTRACTOR SHALL HAVE ONSITE	ID		TOWN OR CITY BOUND
	WATER TRUCKS, MISTERS AND CHEMICAL TREATMENT, SUCH AS CALCIUM	⊸ TPL or GUY	TPL or GUY	TRAVERSE OR TRIANGULATION STATION
	CHLORIDE DURING EARTHMOVING ACTIVITIES. ADDITIONALLY, EXCAVATED SOILS	• HTP	TPL 01 GOT	TROLLEY POLE OR GUY POLE
	SHALL BE DIRECTLY TRANSFERRED TO COVERED TRUCKS AND NOT STOCKPILED.	-∳- UFB	UFB	TRANSMISSION POLE
		-\$- UPDL	UPDL	UTILITY POLE W/ FIREBOX
		-\$- ULT	ULT	UTILITY POLE WITH DOUBLE LIGHT
		-6- UPL	UPL	UTILITY POLE W / 1 LIGHT
		OPL	UPL	UTILITY POLE
AF	BREVIATIONS .	•SI7F & TYPF		BUSH

•SIZE & TYPE

• WG

PM

TREE

PM

STUMP

SWAMP / MARSH

PARKING METER

WATER GATE

ABBREVIATIONS +	
-----------------	--

A.C.I.			
BLDG.	BUILDING	U.N.O.	UNLESS NOTED OTHERWISE
CONC.	CONCRETE	REF.	REFERENCE
C.J.	CONTROL JOINT	R.	RISER
COL.	COLUMN	R.O.	ROUGH OPENING
DET.	DETAIL	RM.	ROOM
DIA.	DIAMETER	S/STL.	STAINLESS STEEL
DN.	DOWN	STRUCT.	STRUCTURAL
EL/ELEV.	ELEVATION	SPEC.	SPECIFICATIONS
ELEC.	ELECTRICAL	T.O.	TOP OF ()
EQ.	EQUAL	T.O.CONC.	TOP OF CONCRETE
FIN.	FINISH	T.O.F.	TOP OF FRAMING
FLR.	FLOOR	T.O.STL.	TOP OF STEEL
GALV.	GALVANIZED	T.O.W.	TOP OF WALL
GYP.	GYPSUM	TYP.	TYPICAL
I.D.	INSIDE DIAMETER	@	AT
JT.	JOINT	+	AND
MECH.	MECHANICAL	BD.	BOARD
MIN.	MINIMUM	A.F.F.	ABOVE FINISHED FLOOR
N.T.S.	NOT TO SCALE	U.N.O.	UNLESS OTHERWISE NOTED
NO.	NUMBER	V.I.F.	
O.C.	ON CENTER		


OPENING


DESIGNED BY JRG DRAWN BY CHECKED BY


PR24406129- NOTES AS NOTED ROJECT NO.: 24012


8

SHEET **2** OF **11**

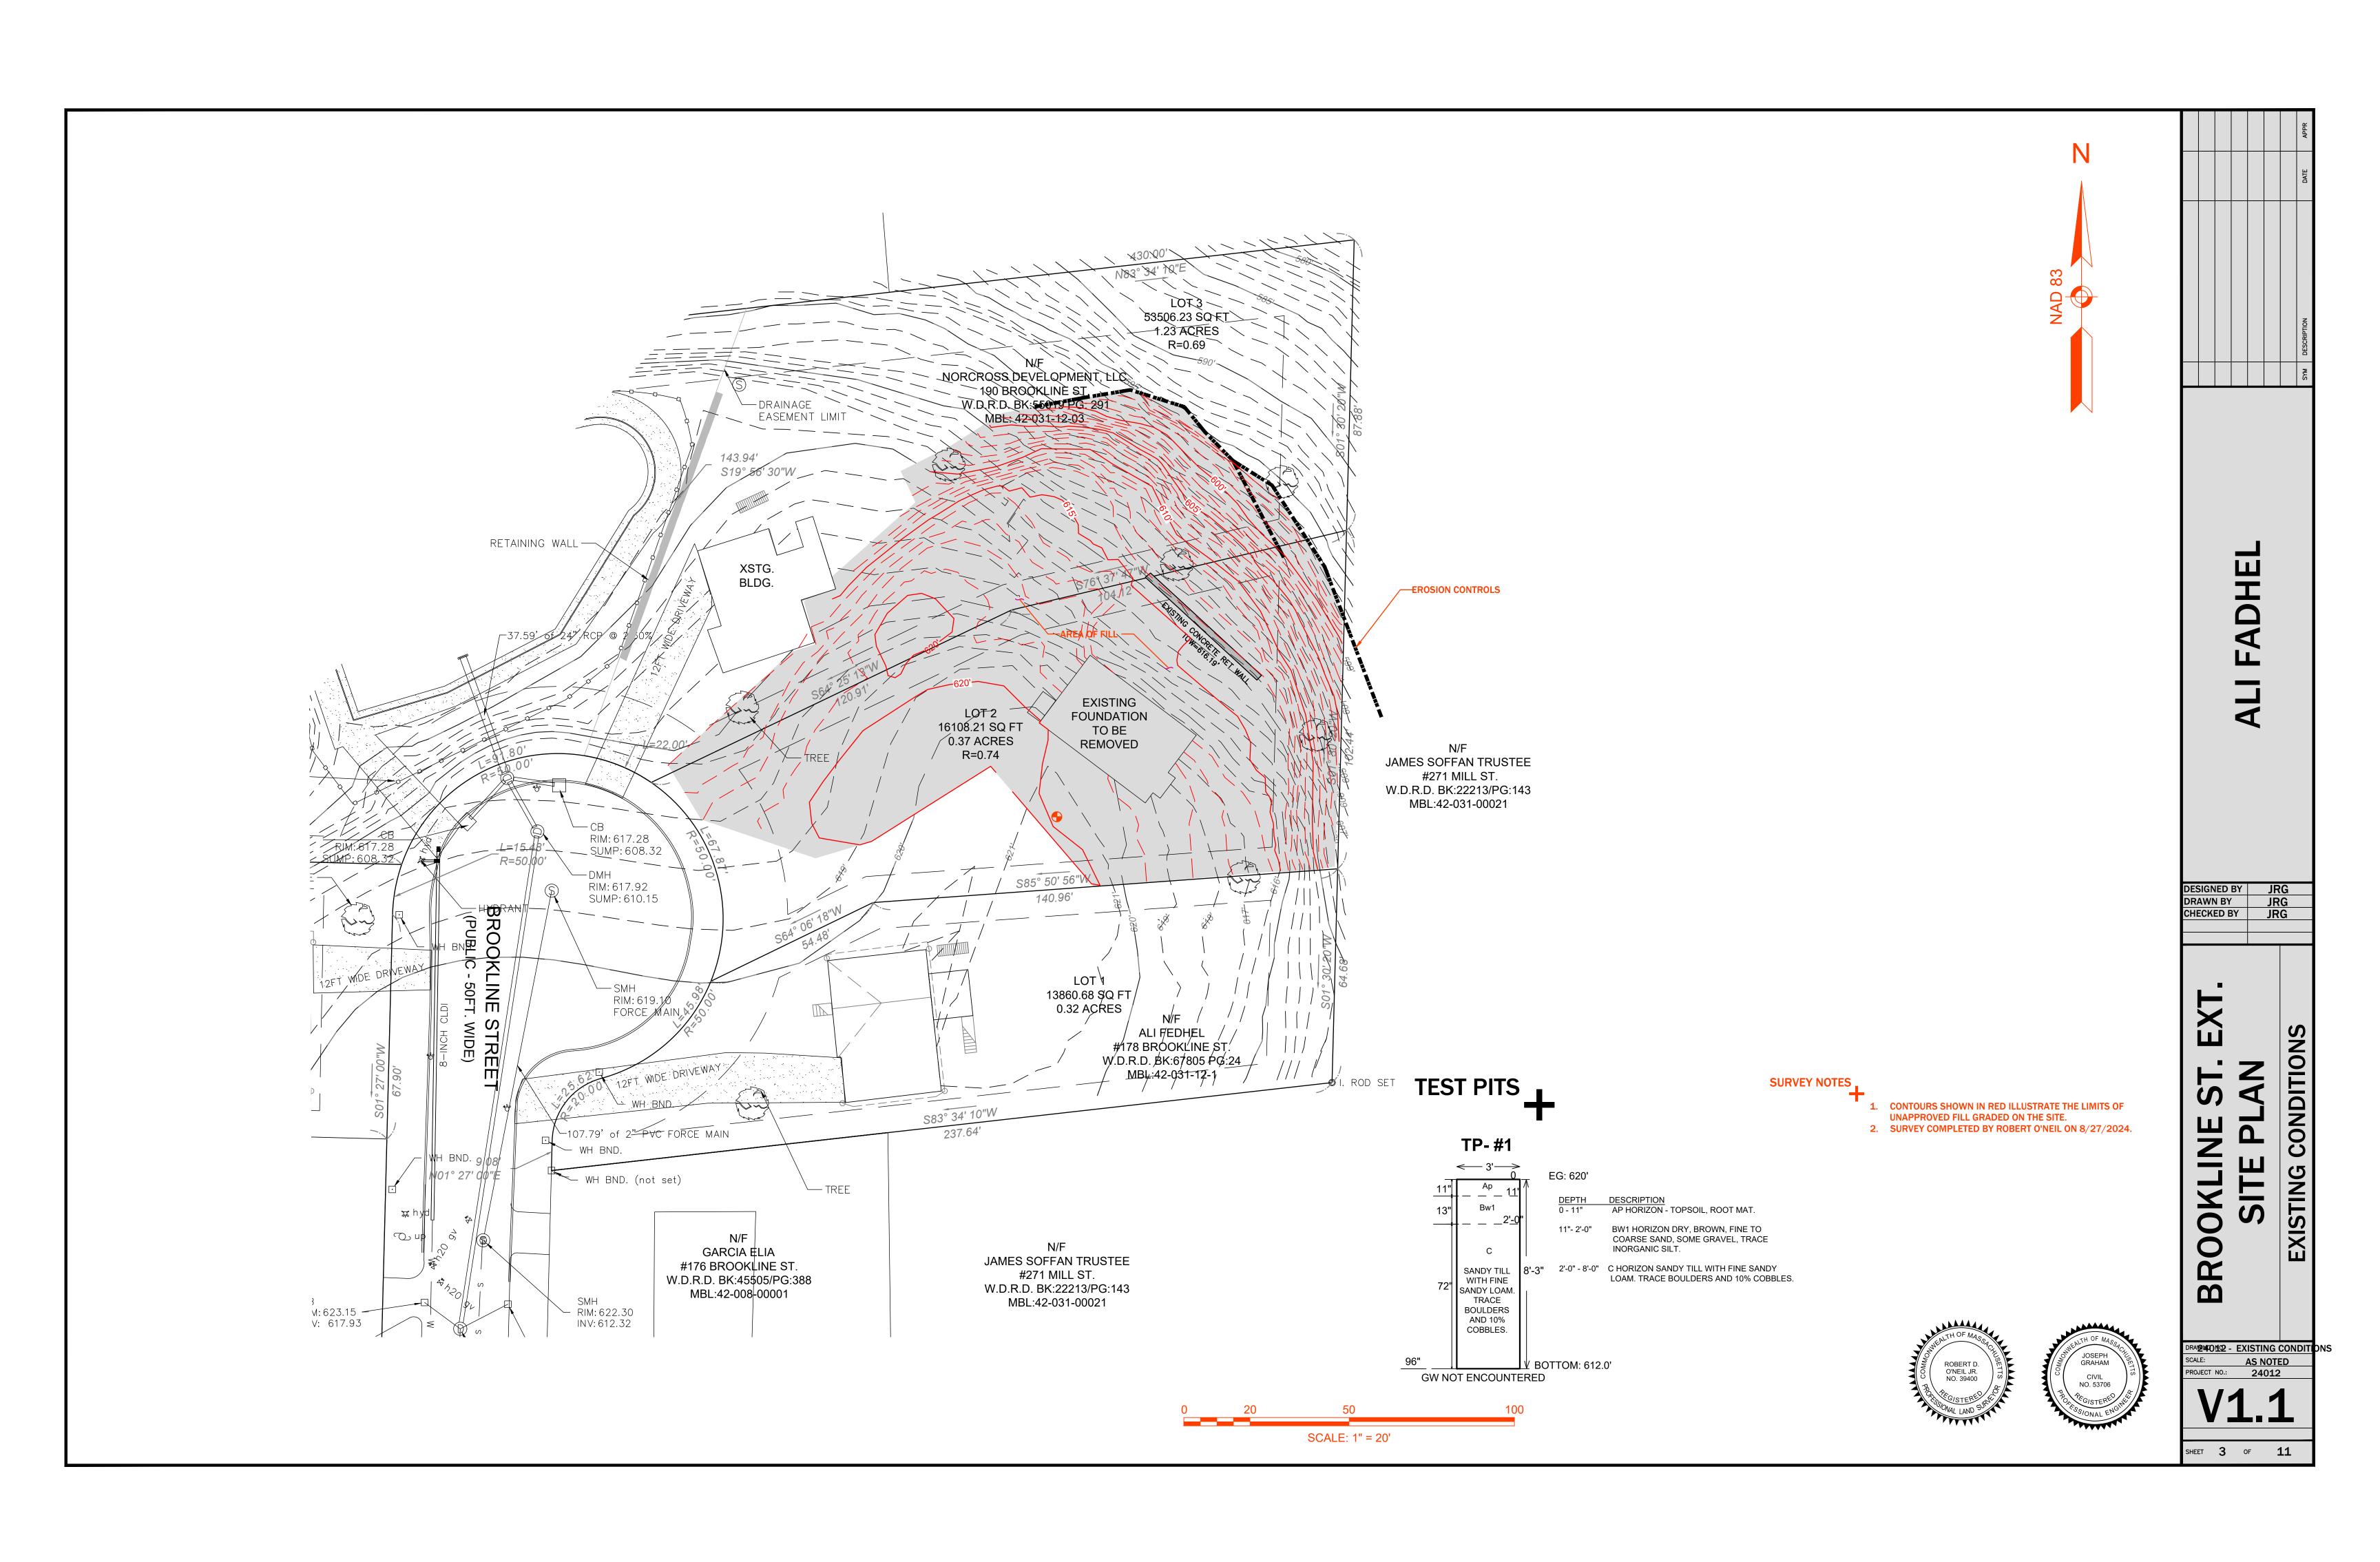

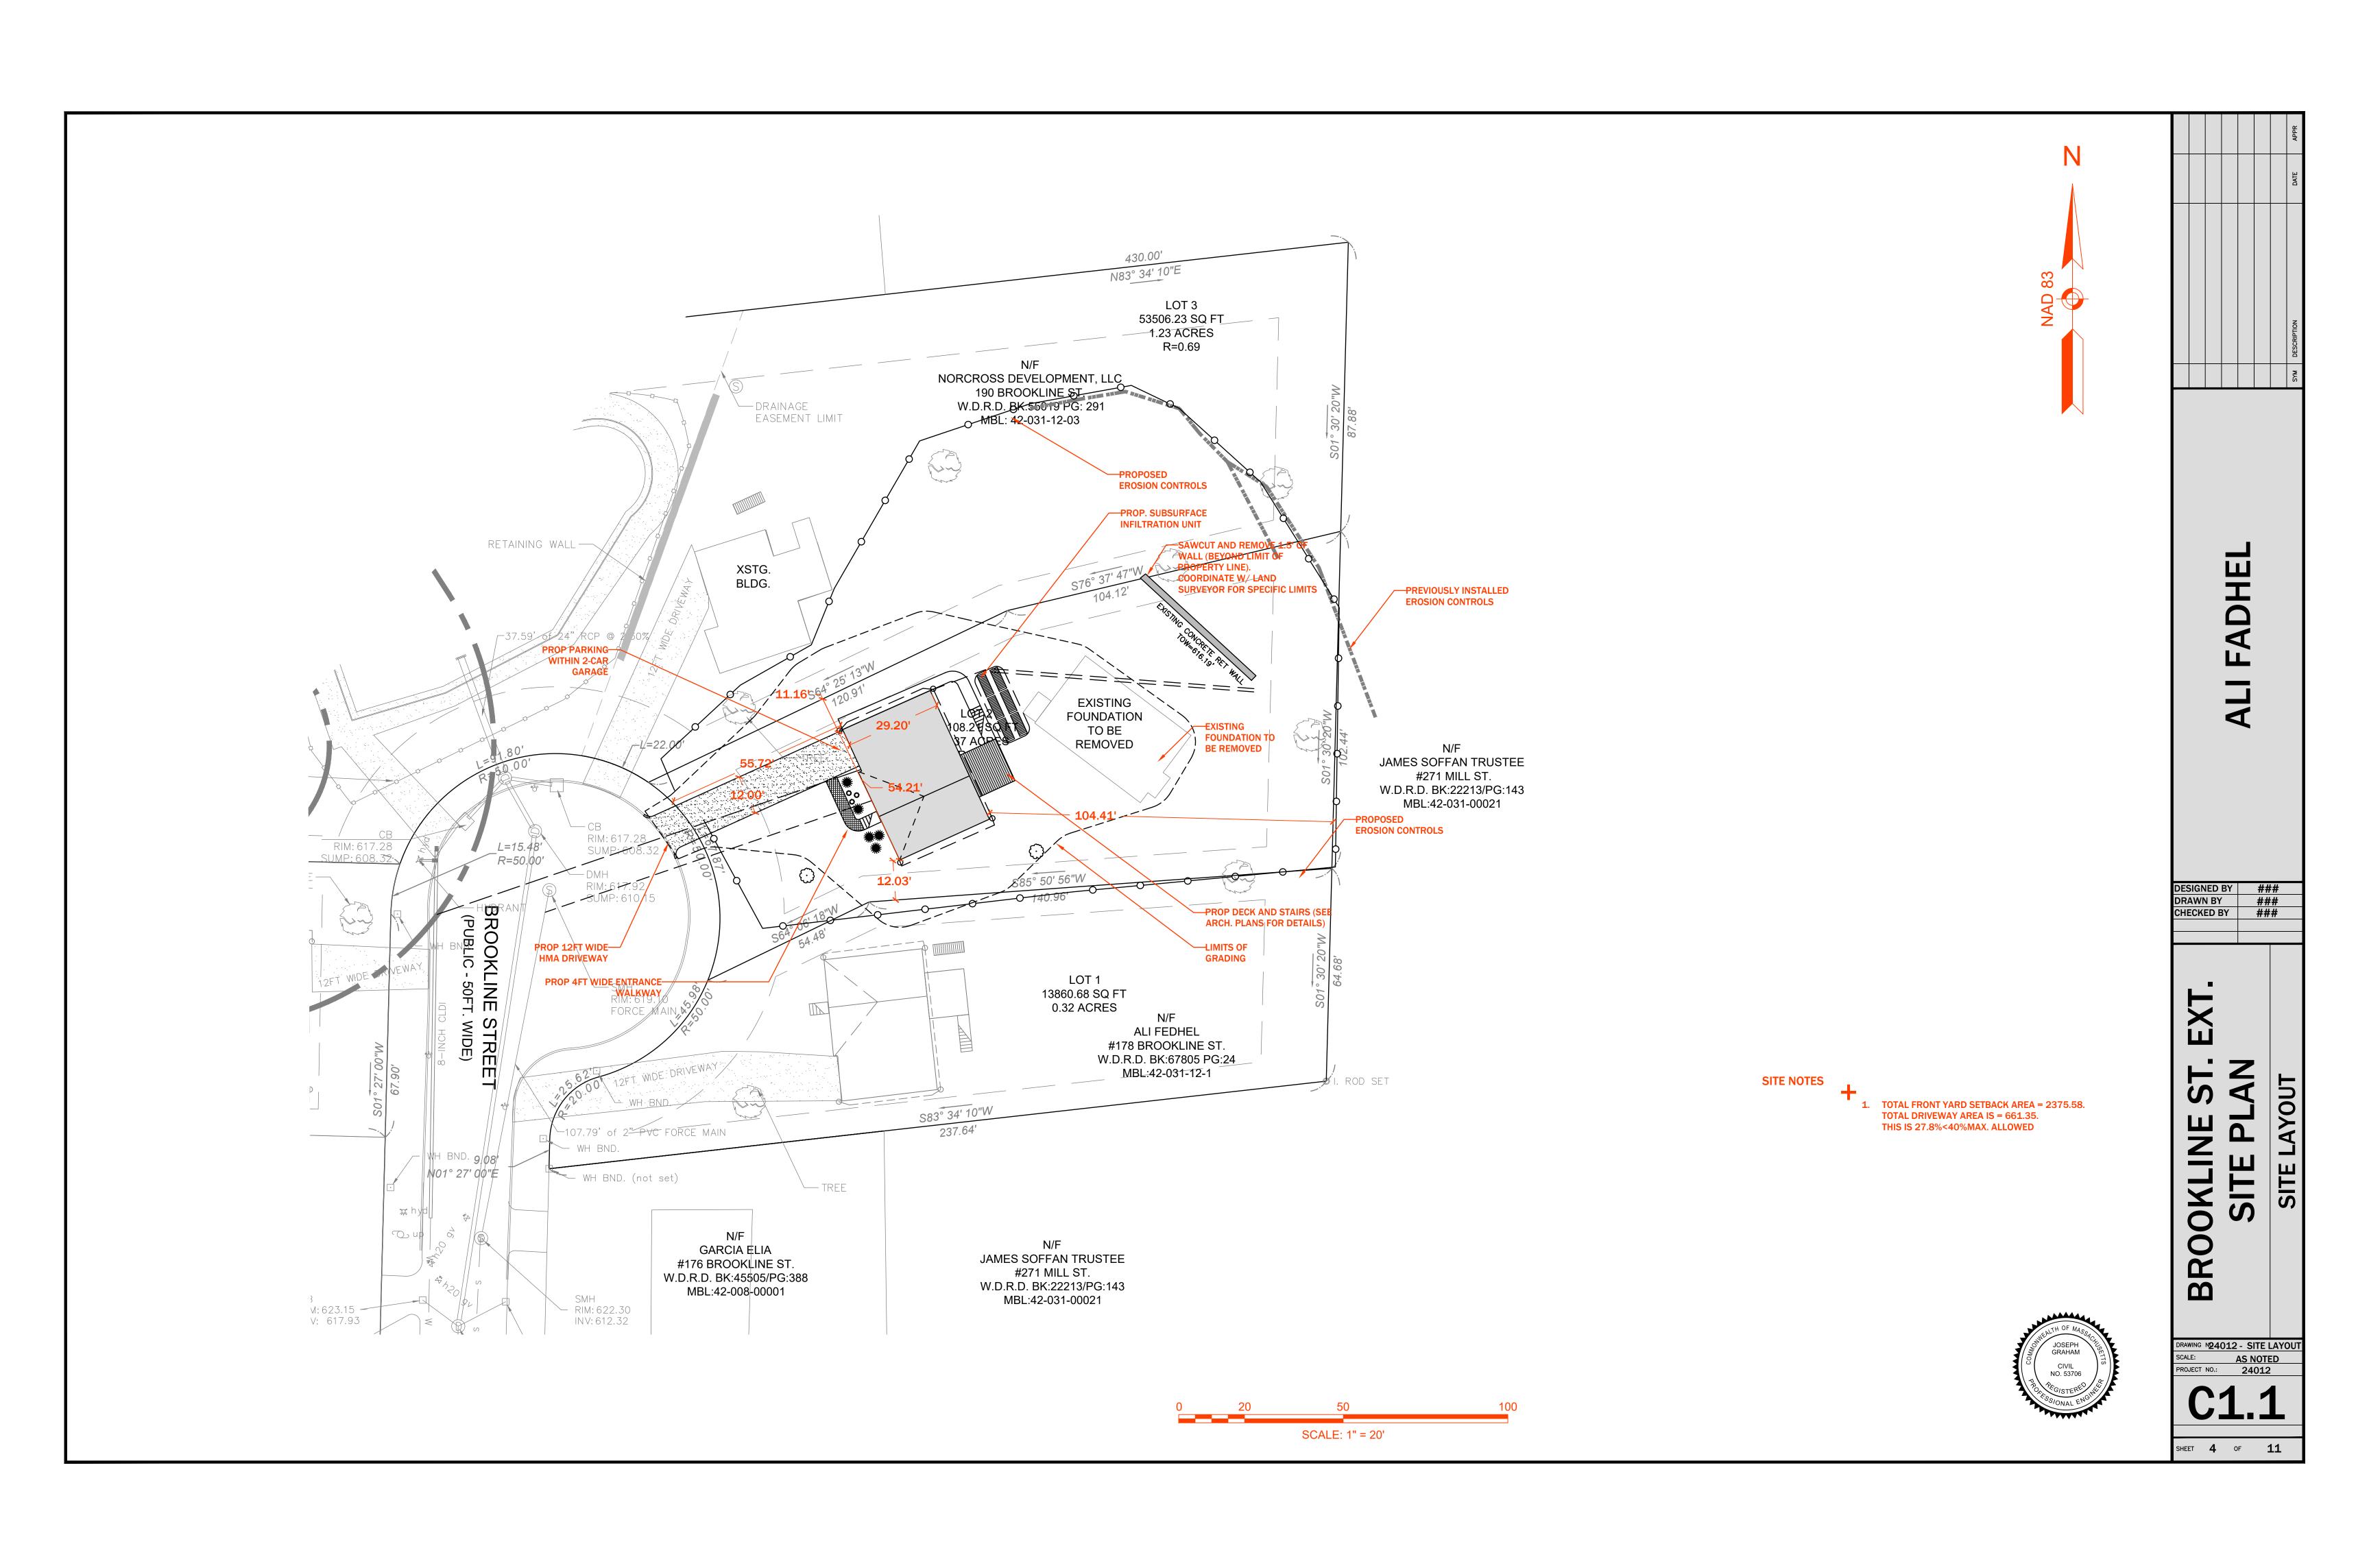

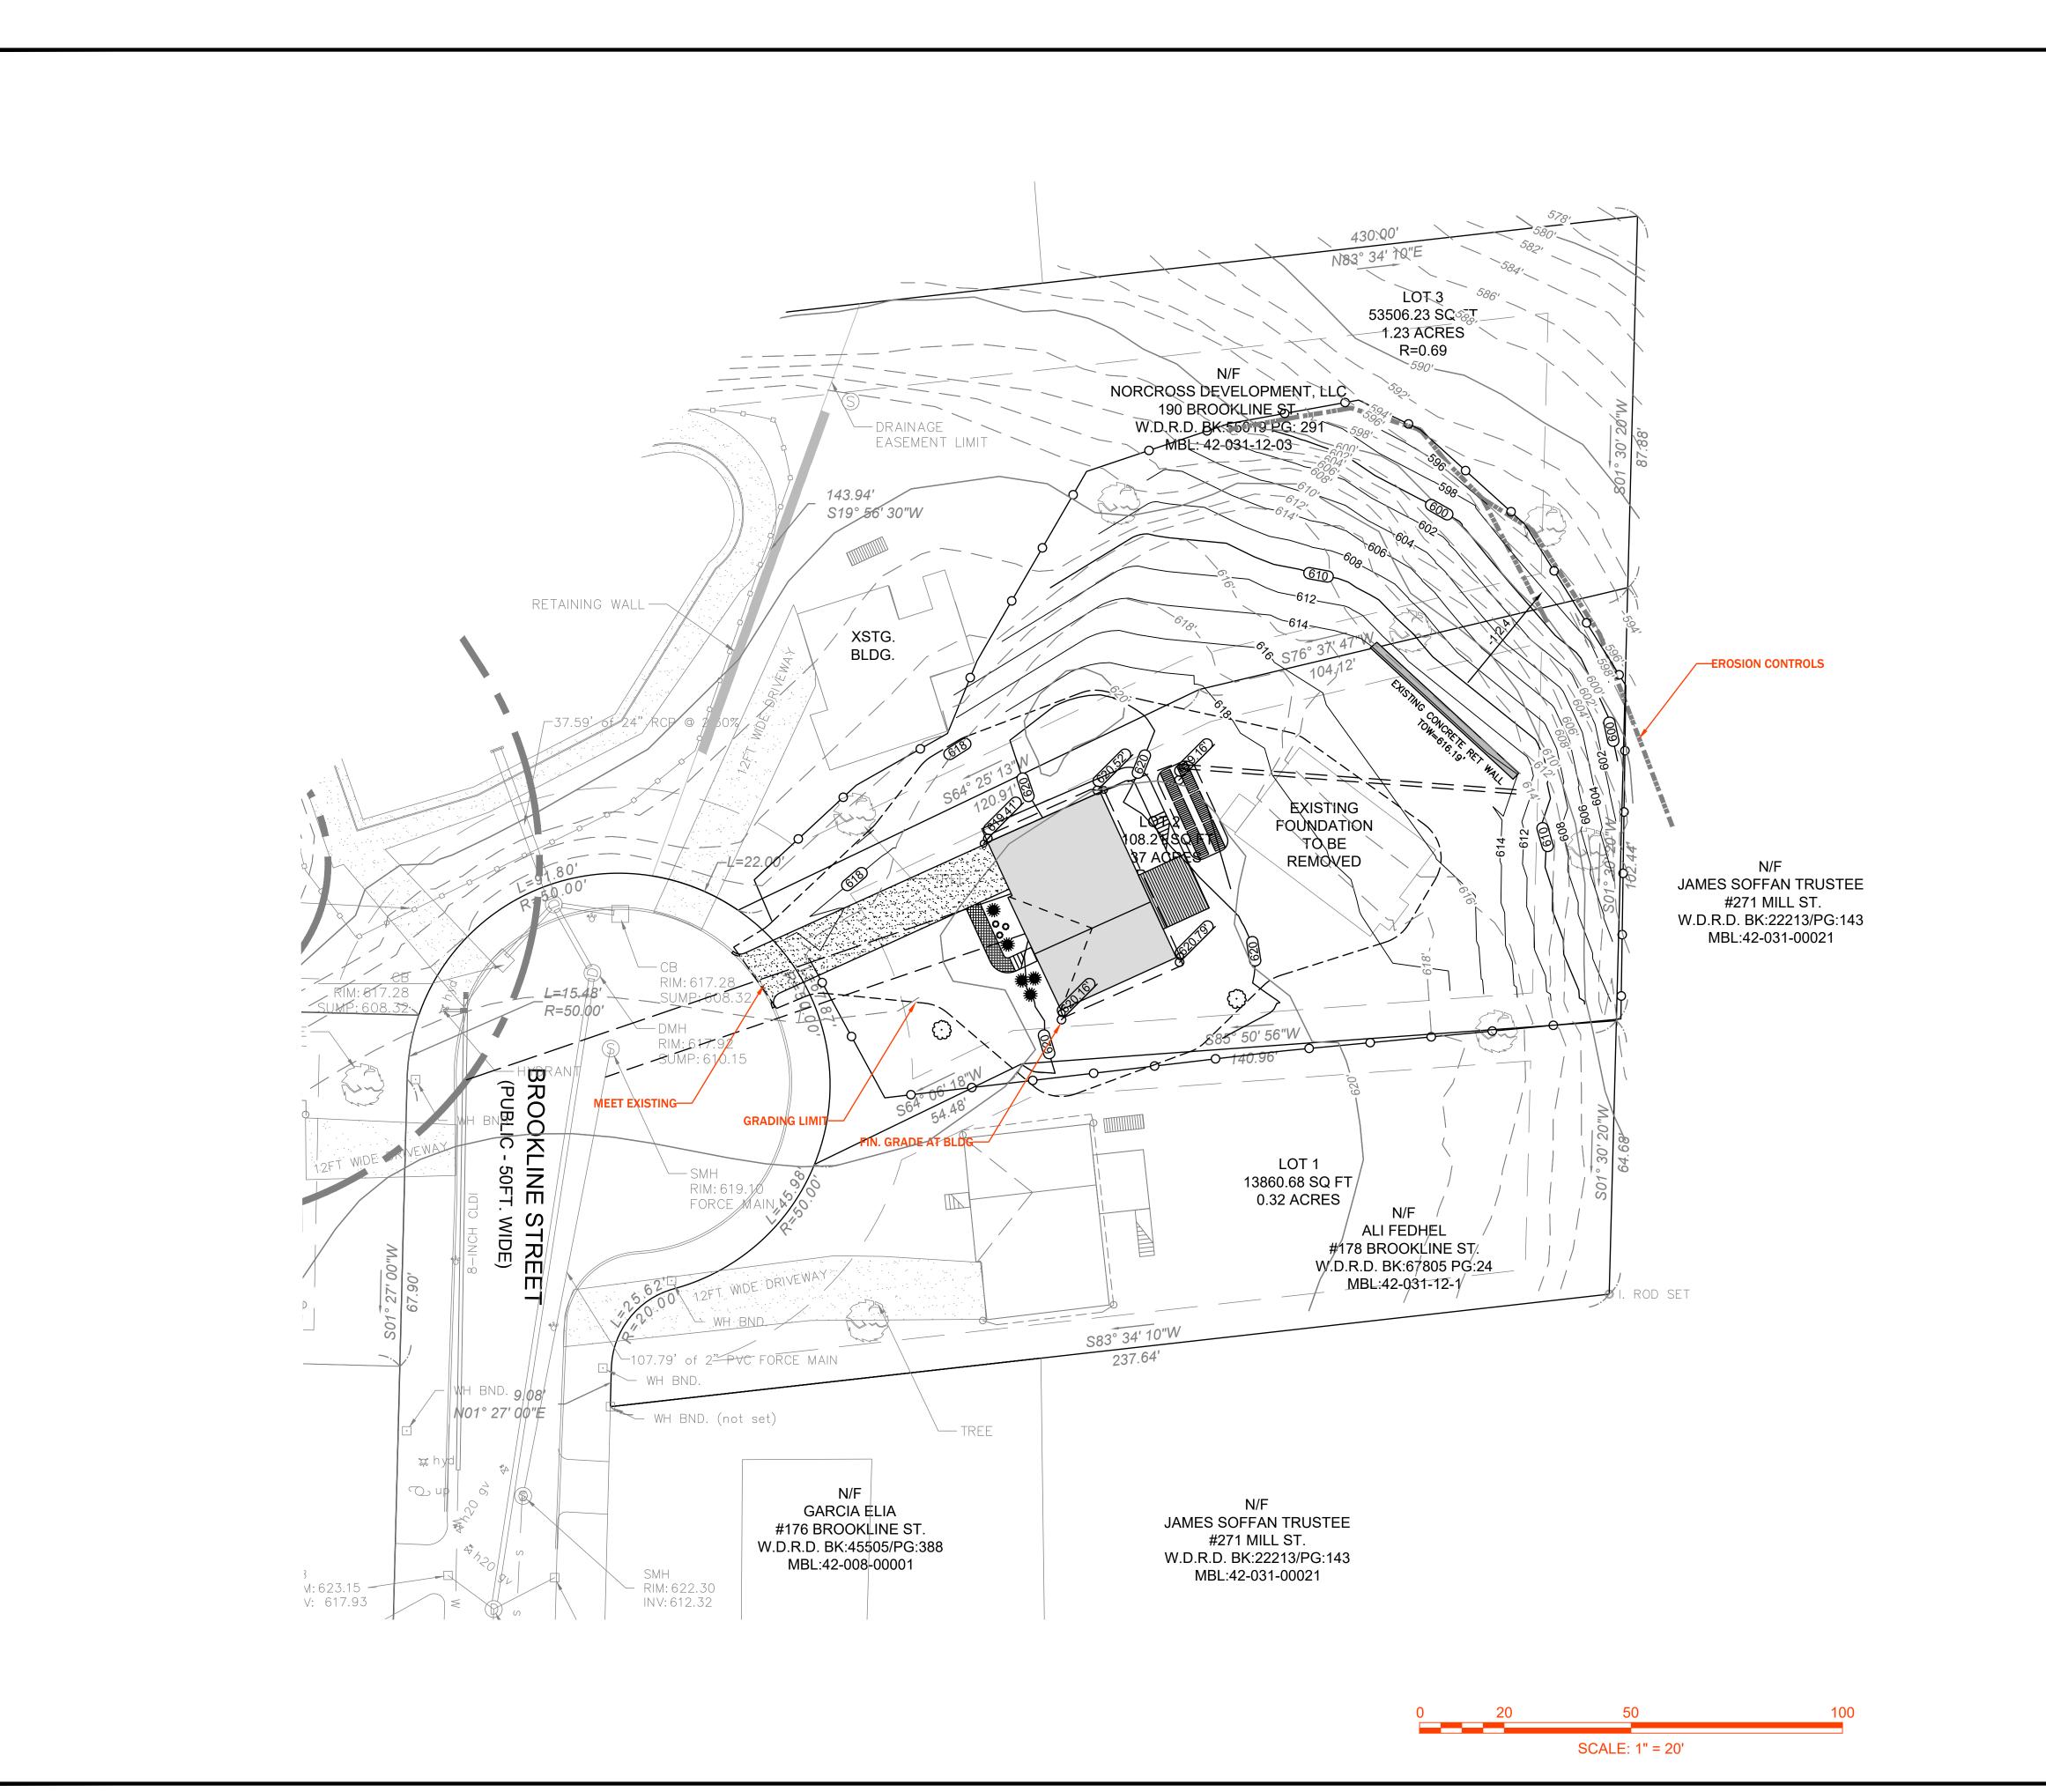

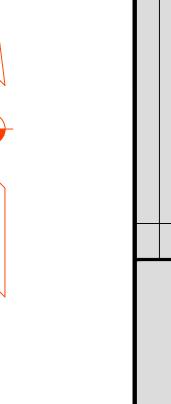

FADHEL

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DRAWN BY ###
CHECKED BY ###

BROOKLINE

GRADING PLAN


MAX SLOPE 2:1. IN AREAS OF MAX SLOPE OF 2:1 CONTRACTOR TO INSTALLED EROSION CONTROL MATTING.
 PLEASE SEE EROSION CONTROL PLAN AND LANDSCAPING PLAN FOR EROSION CONTROL MATTING LIMITS.





DRAWI**24012 - GRADING & UTI** AS NOTED PROJECT NO.: 24012

SHEET **5** OF **11**

GRADING NOTES

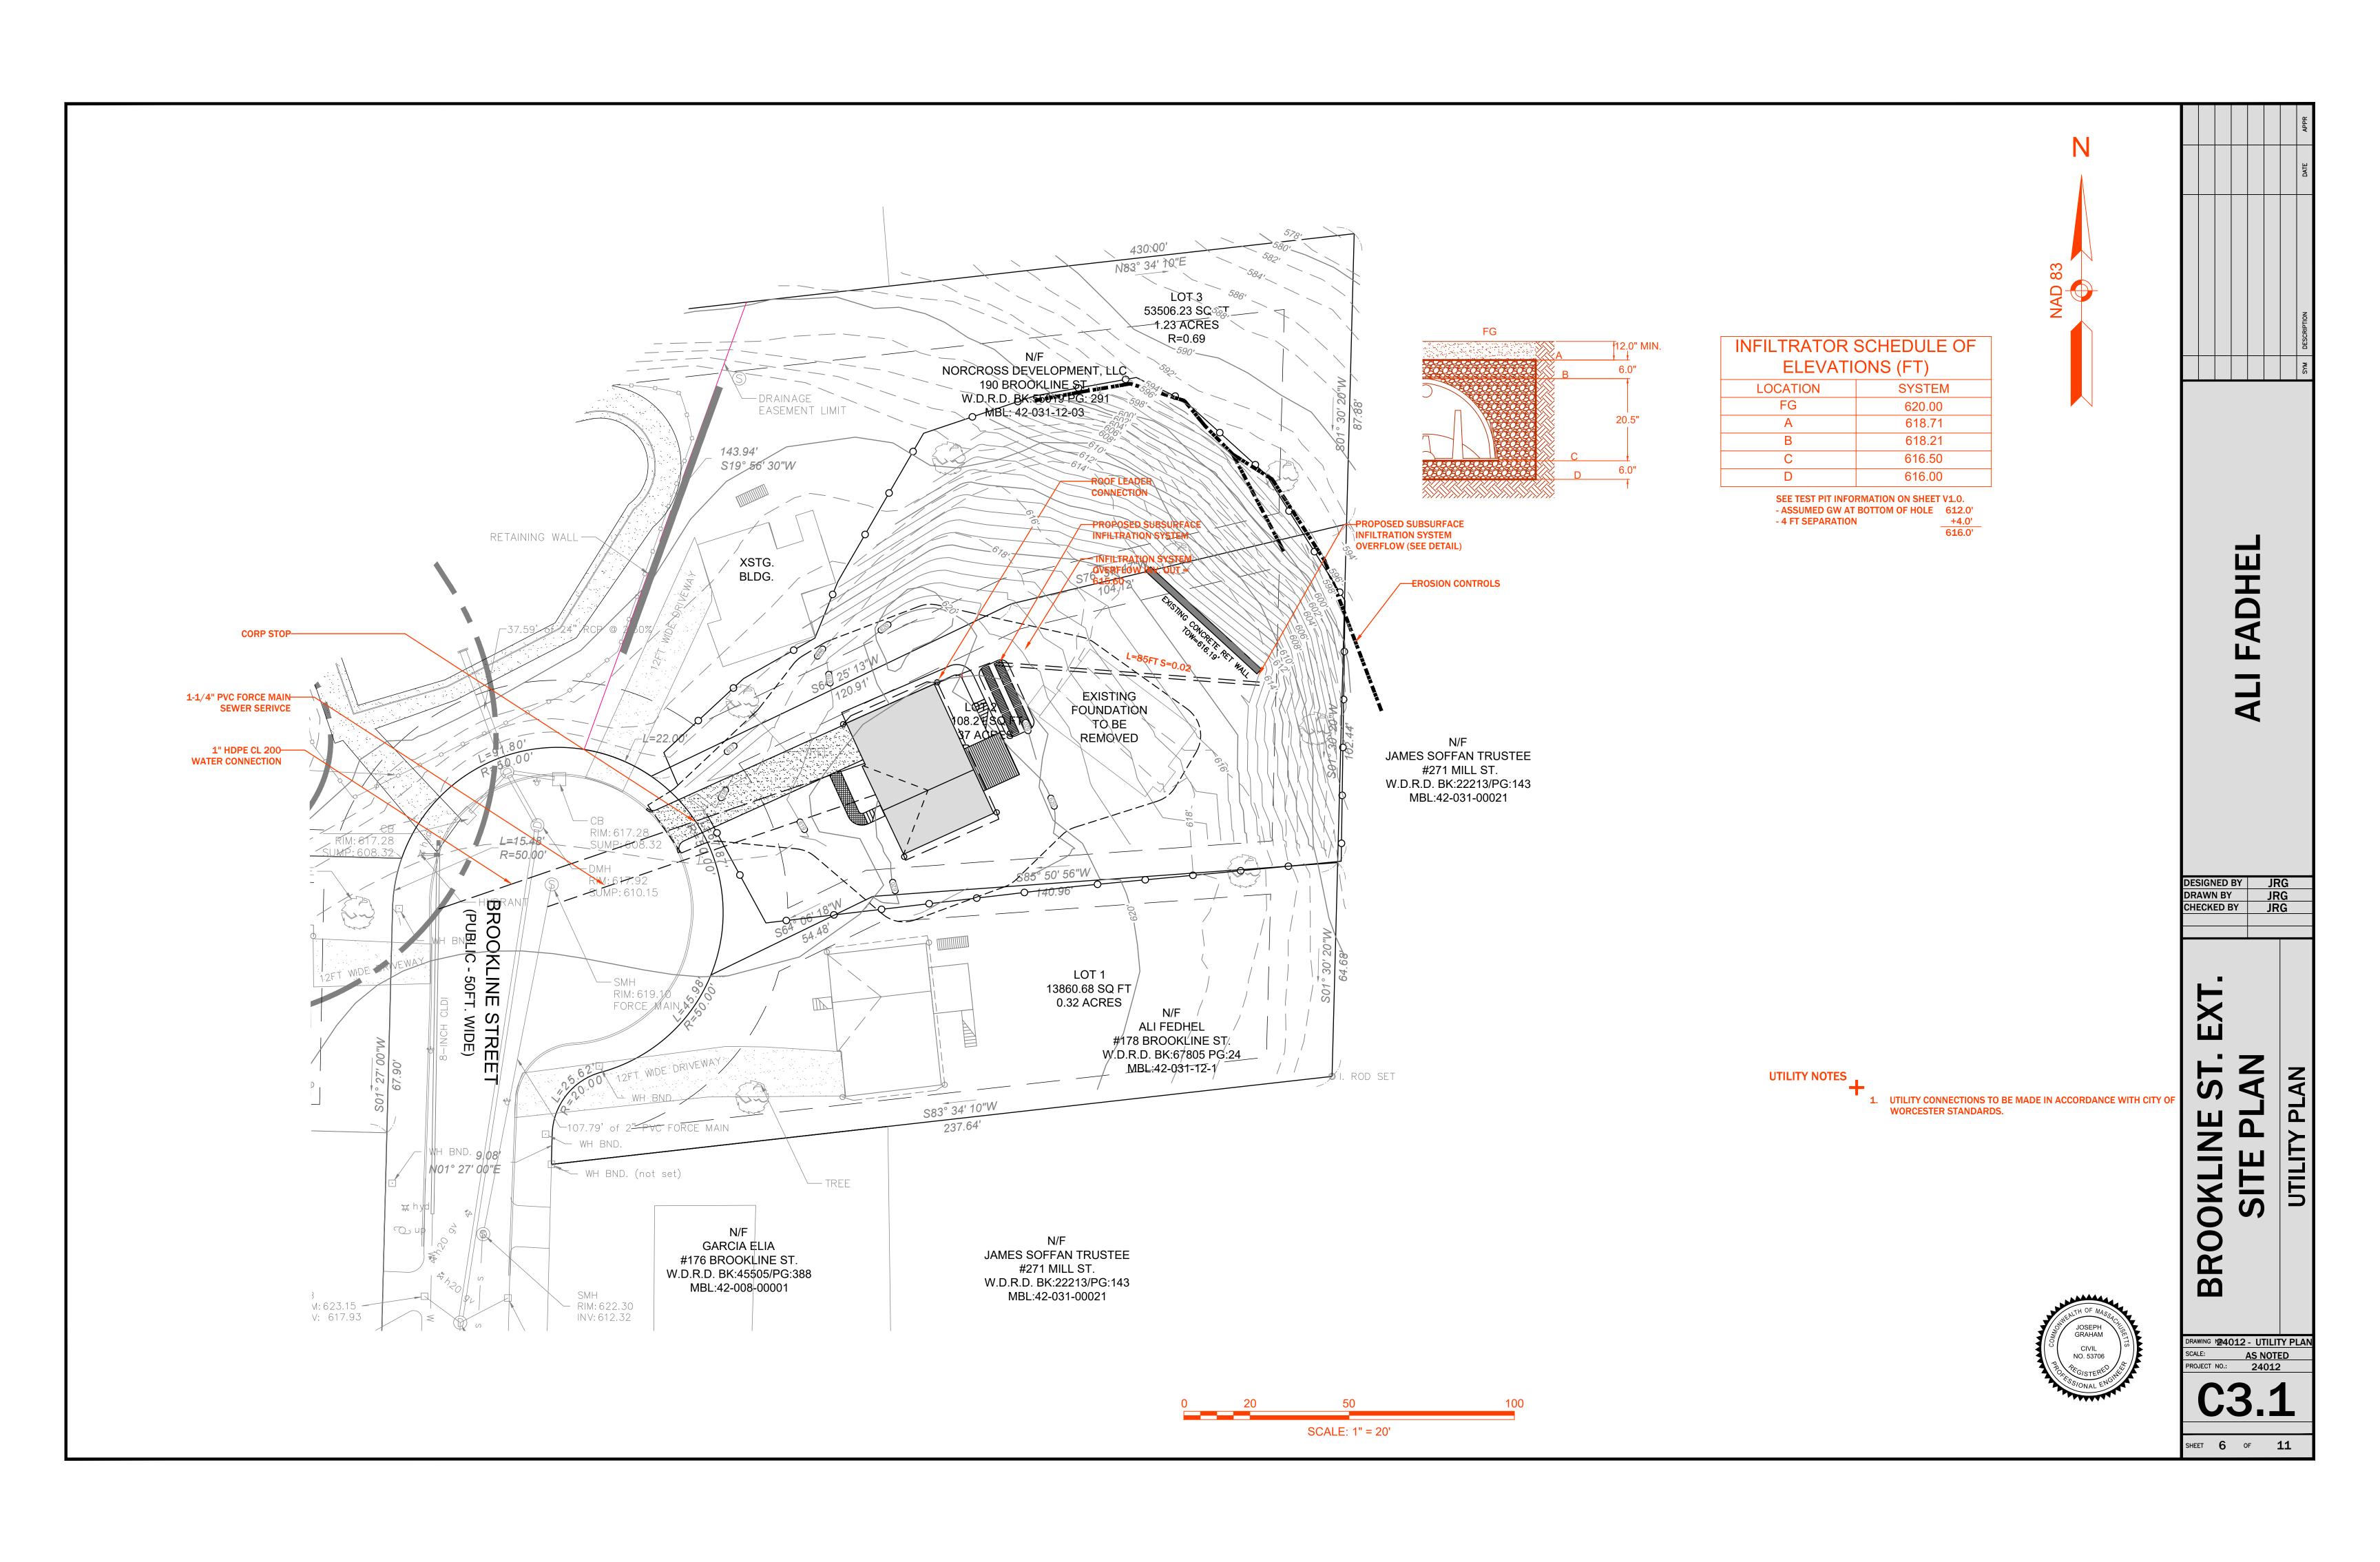

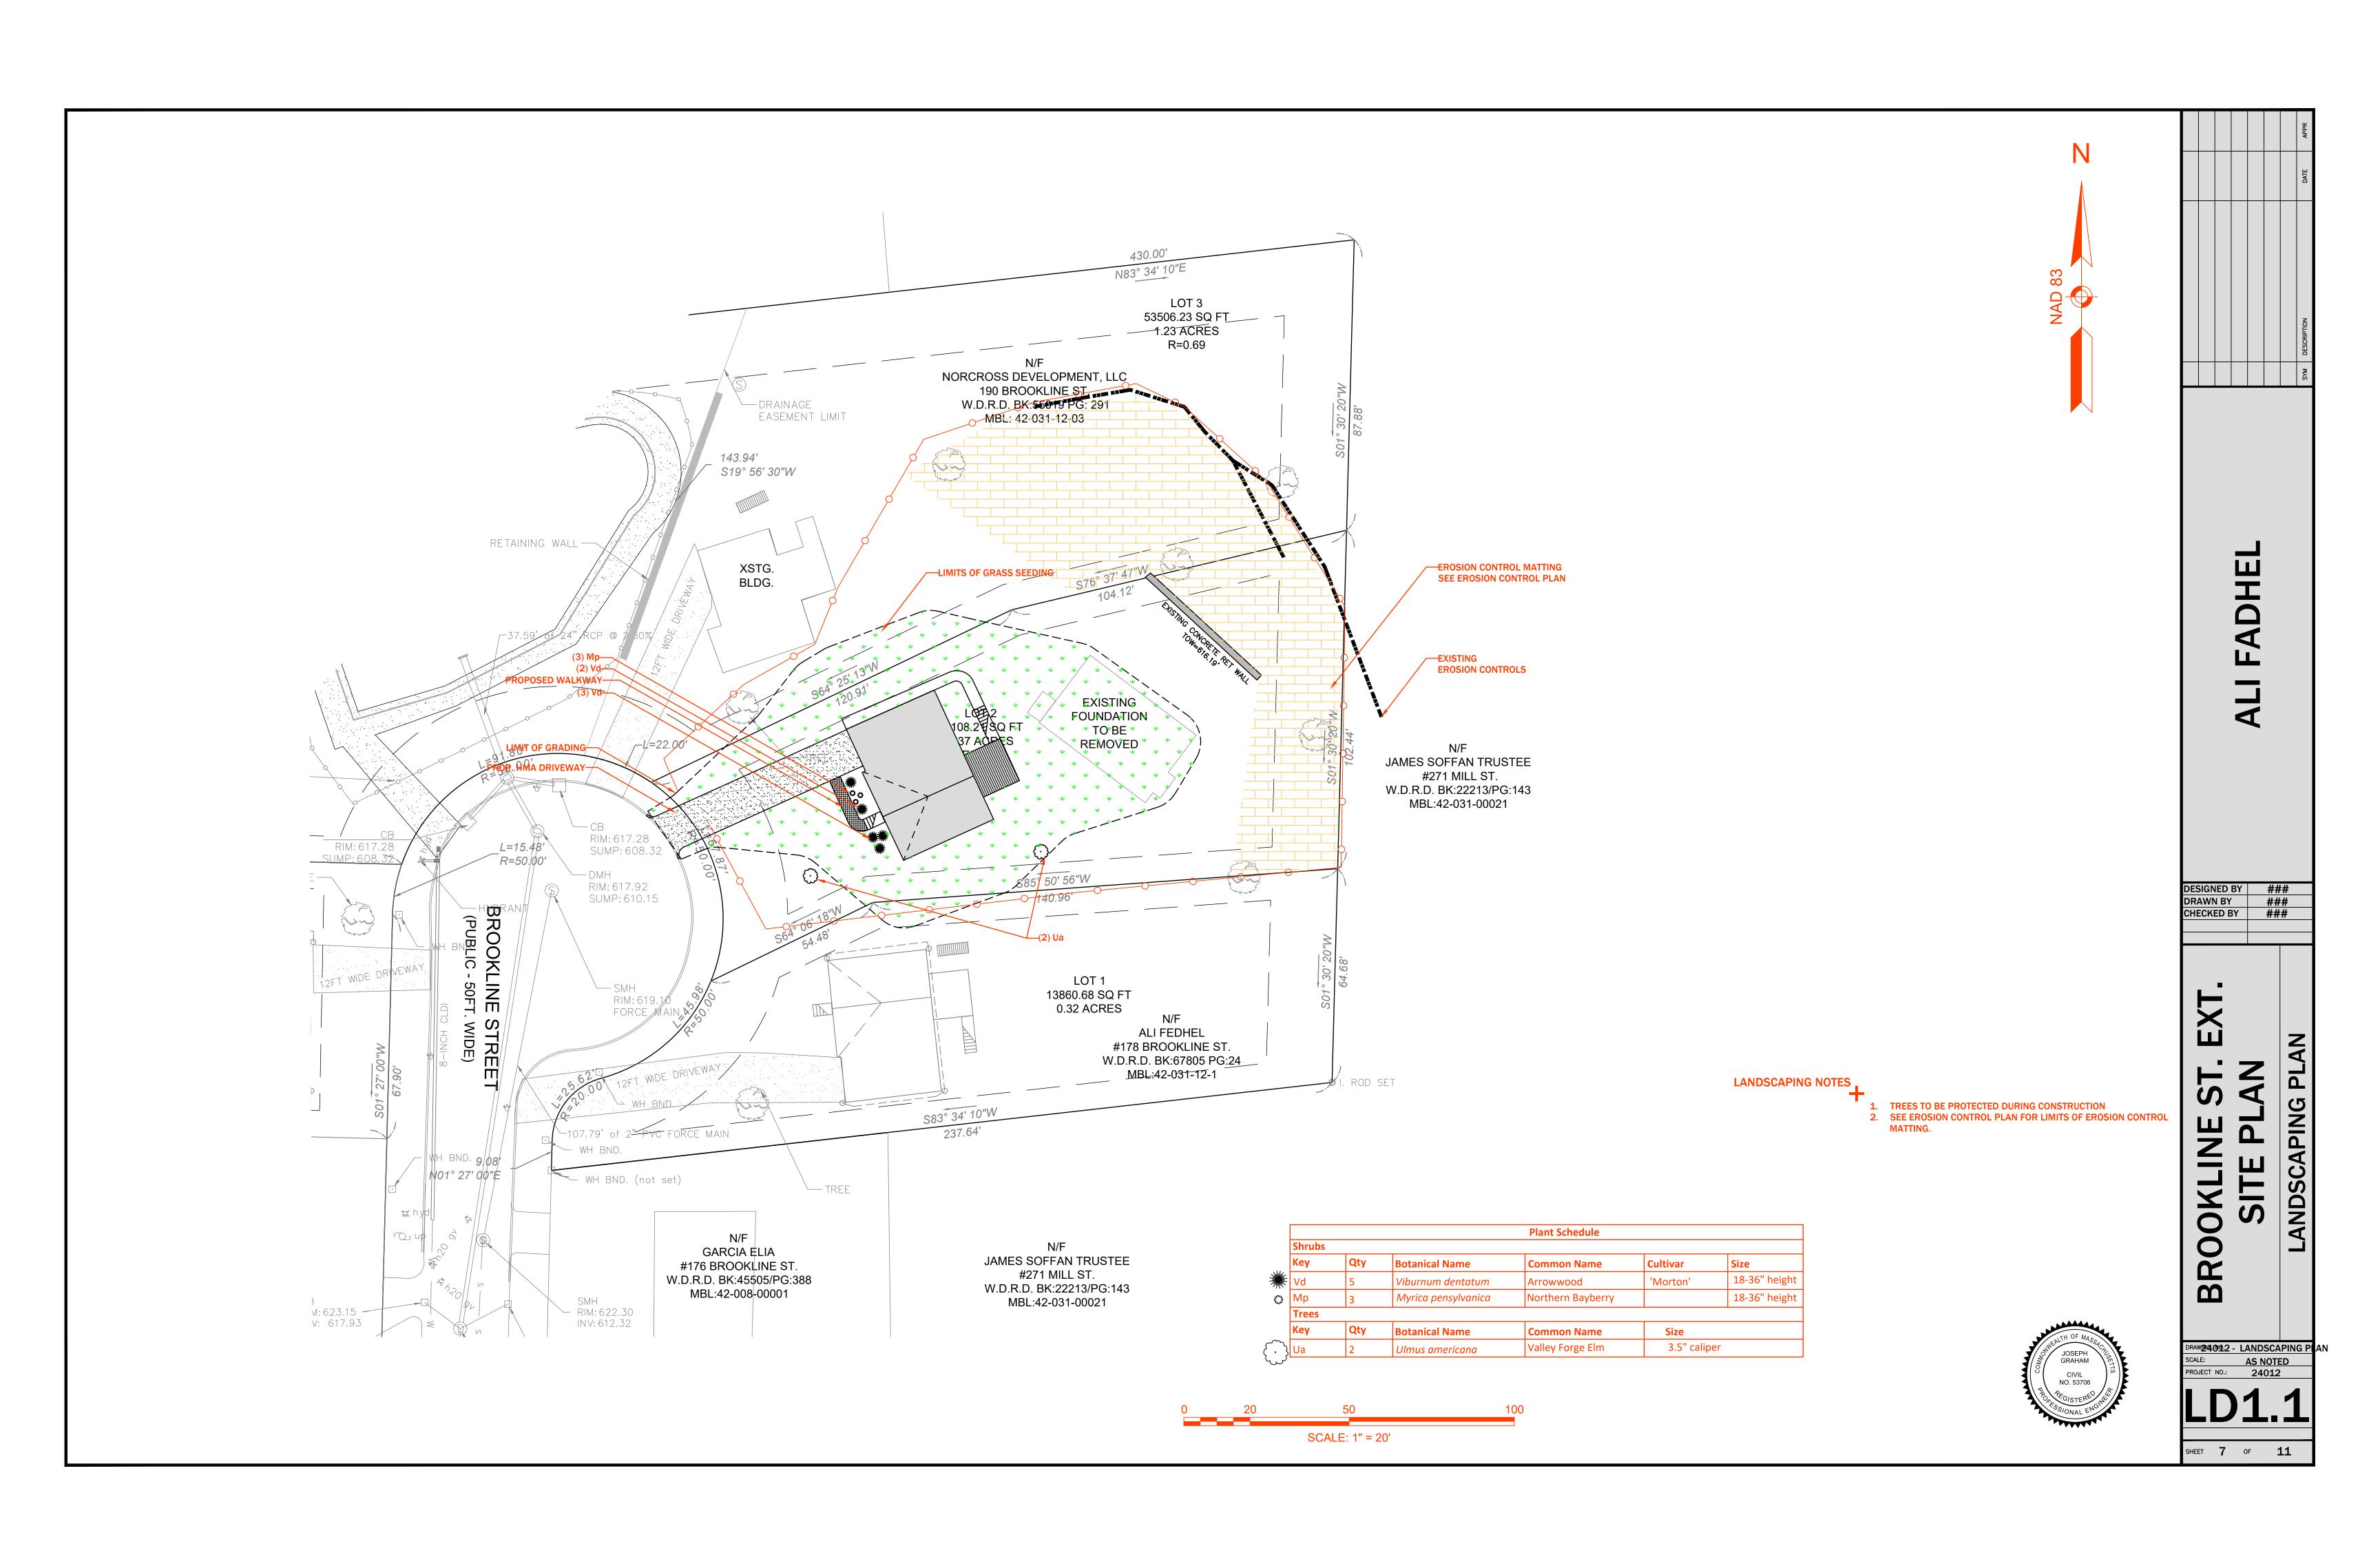

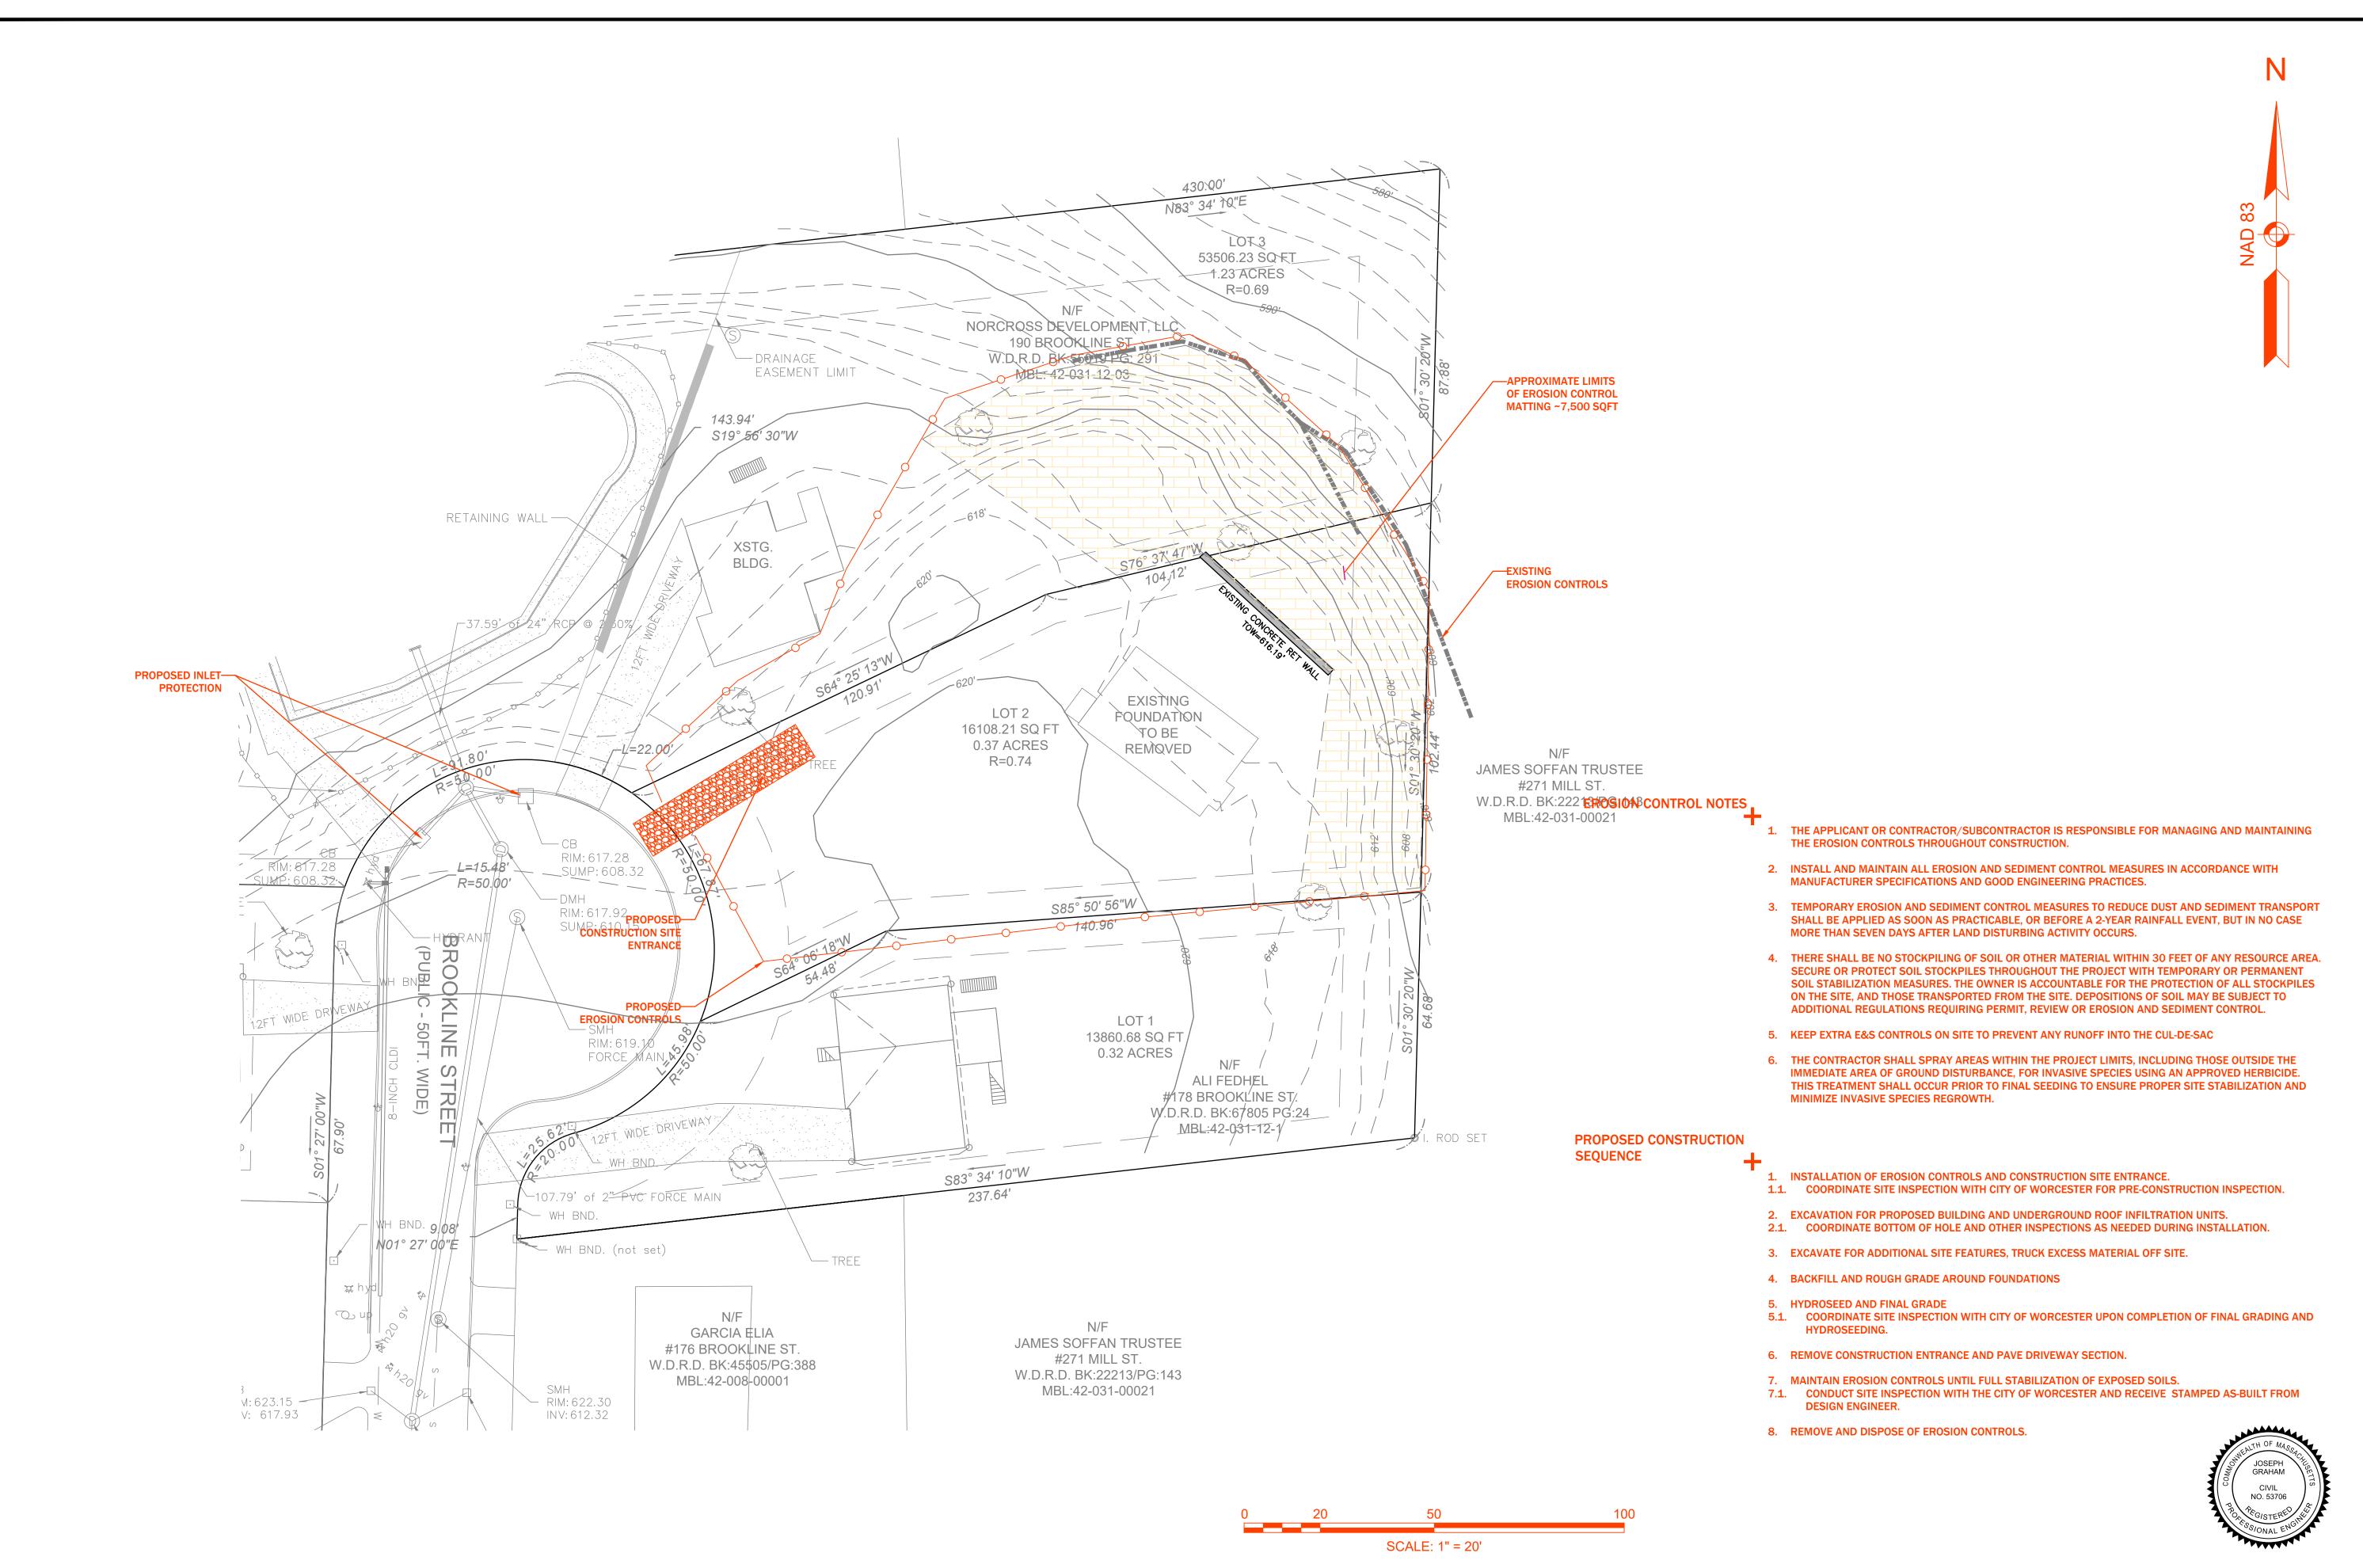

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DRAWN BY JRG
CHECKED BY JRG


DRAWN BY JRG


SOOKLINE ST. EX SITE PLAN ROSION CONTROL PLAN


DF24409120- EROSION CONTROL PLAN
SCALE: AS NOTED

PROJECT NO.: 24012


SHEET **8** OF **11**

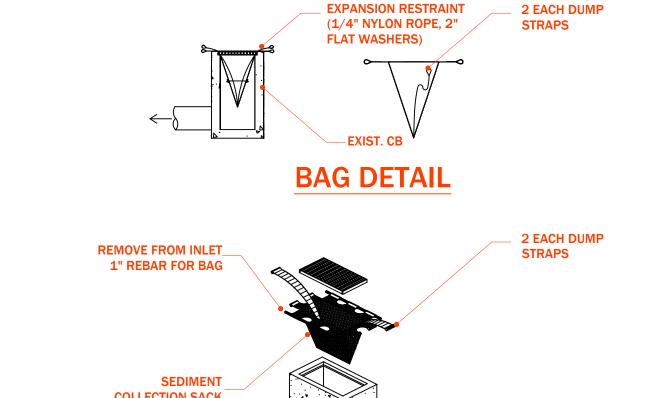

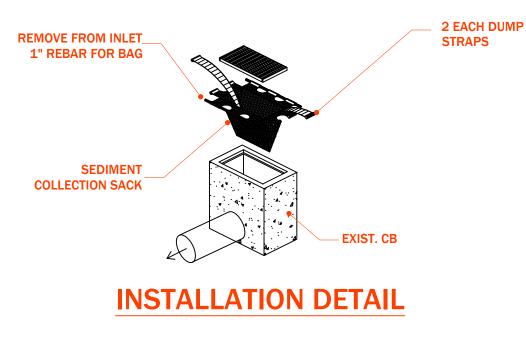

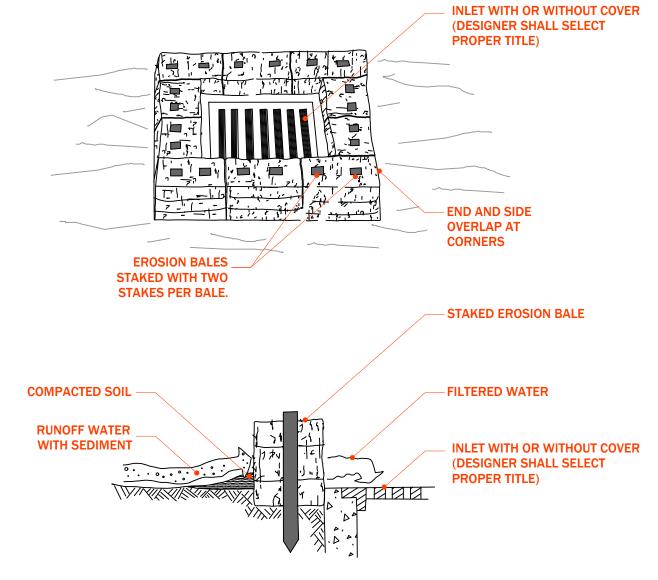



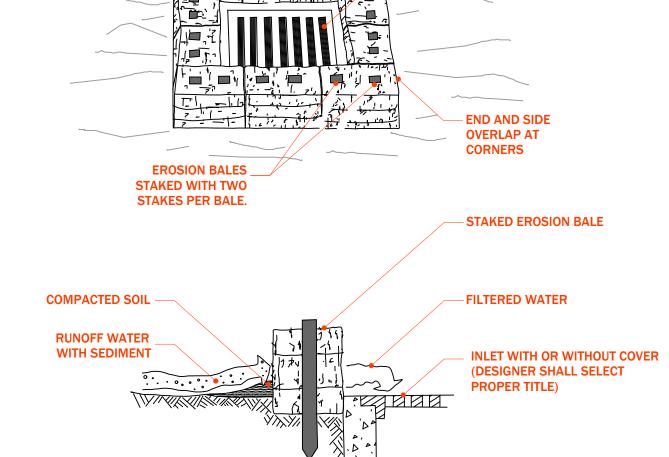



1"x1"x5' WOOD

STAKES - 4' O.C.

FILTER FABRIC - INSTALL PER MANUFAC. SPECIFICATIONS

BURY FILTER FABRIC IN 6" x 6" TRENCH



WOOD POST (TYP.)

PLAN

EXISTING GRADE

REDUCE WATER FLOW

ONTO WORK ZONE

__HAY BALE WITH 2 WOODEN STAKES PER BALE (TYP.)

SECTION A-A

X 1" WOOD LATH STRIPS SECURED WITH 4d COMMON NAILS (BOX NAILS).


SECTION B-B


PREVENT FLOW OFF SITE.


BIODEGRADABLE FABRIC






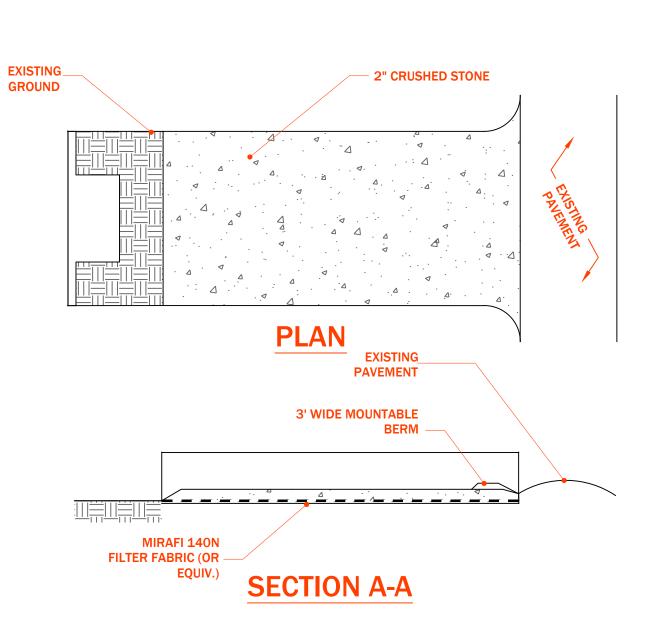

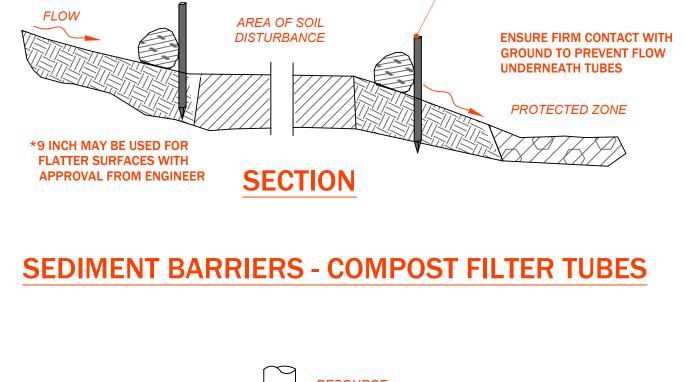

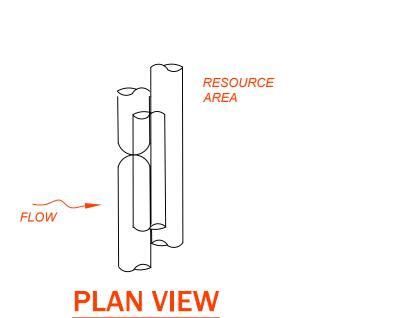


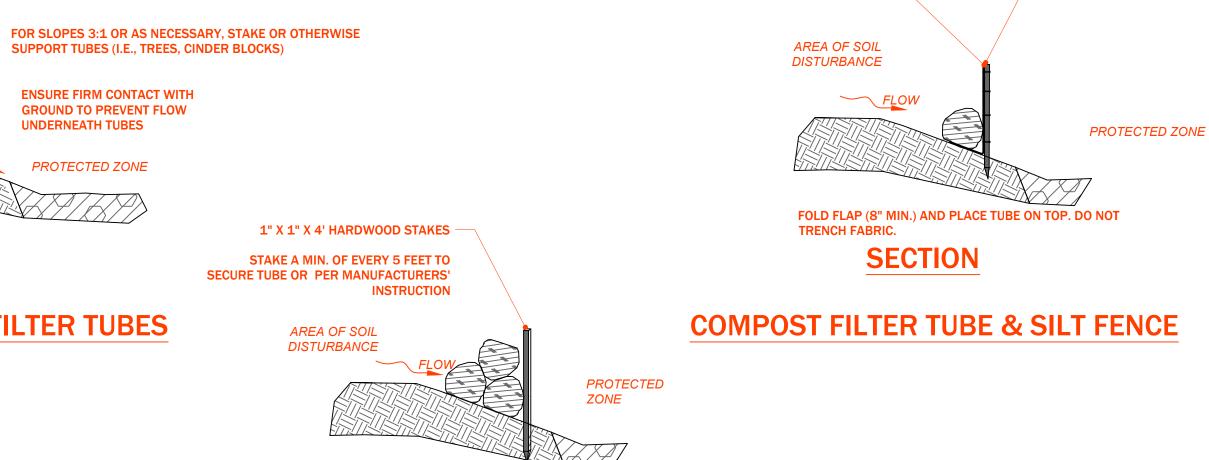

WOVEN POLYPROPYLENE

FIBER FABRIC

SECTION COMPOST FILTER TUBE BERM (SLOPES 2:1 OR STEEPER)

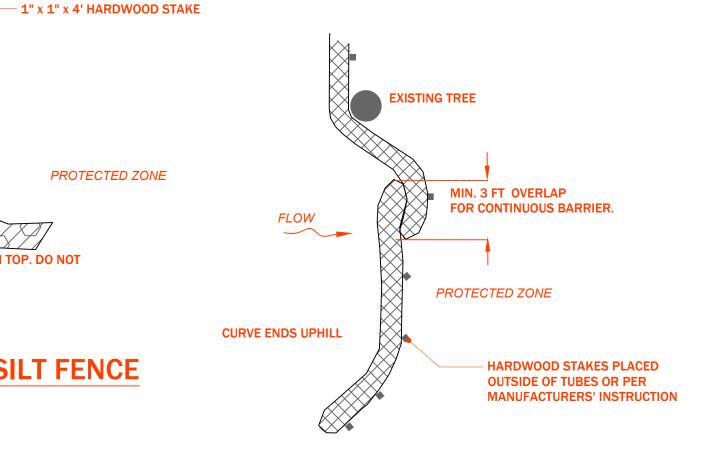

PLACE TUBE ALONG CONTOURS AND PERPENDICULAR TO FLOW. PLACE AS CLOSE TO LIMIT OF SOIL DISTURBANCE AS POSSIBLE ADJUST LOCATION AS REQUIRED FOR OPTIMUM EFFECTIVENESS. DO NOT INSTALL IN WATERWAYS. PLACE STAKES AS NEEDED TO SECURE TUBES IN PLACE.

> **PLAN VIEW SEDIMENT BARRIERS**

CONSTRUCTION ENTRANCE





DESIGNED BY JRG DRAWN BY CHECKED BY

FADHEL

OKLIN **DETAIL** BRO CONST.

AWING 24012 - CONST. DETAIL AS NOTED PROJECT NO.: 24012

SHEET **9** OF **11**

CONST.

PROJECT NO.: 24012

SHEET **10** OF **11**

PRUNE PER ISA STANDARDS. REMOVE DEAD & DAMAGED BRANCHES. TIE BRANCHES UP TO AVOID DAMAGE FROM CONSTRUCTION EQUIPMENT. -WOODEN OR METAL POSTS FOR PROTECTION (IF REQUIRED) —A WATER SAUCER SHALL BE FORMED AROUND THE BASE OF ALL TREES GROWTH COLLAR AREA SHALL BE SLIGHTLY ABOVE THE PROPER TREE PLANTING GRADE IN REFERENCE TO TREE SETTLEMENT AFTER PLANTING. ROLL BURLAP BACK 1/3 BEFORE BACKFILLING EXISTING GRADE / FINISHED GRADE

PLANTING SOIL, MIN 2 FERTILIZER PACKETS


W/ 3YR RELEASE


-- UNDISTURBED SUBGRADE

SET IN FIELD

- 1. CONTRACTOR TO LOCATE ALL UNDERGROUND UTILITIES SPRINKLER SYSTEMS, CITY WATER GATES, AND ETC. BEFORE DIGGING TREE PLANTING PITS.
- 2. NO TREE STAKES AND NO WRAP REQUIRED.
- 3. ROOT BALL SHALL BE SET ON COMPACTED SOIL AREA TO REDUCE SETTLEMENT OF THE TREE.




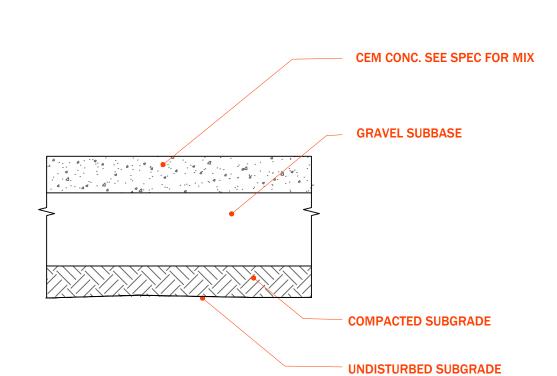

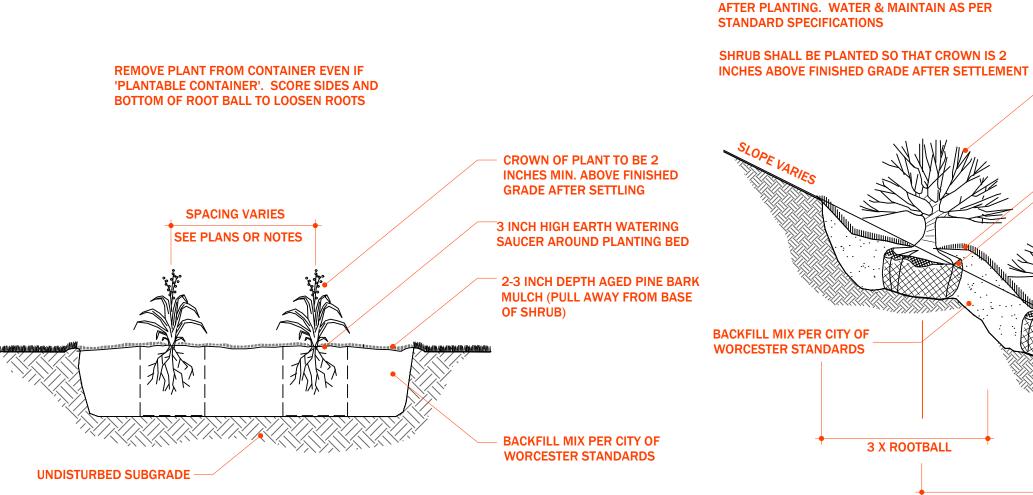


- 1. EXCAVATE TO REQUIRED DEPTH AND BACKFILL WITH PLANTING MIX.
- 2. RAISE AND REPLANT ANY PLANTS THAT SETTLE MORE THAN 3 INCHES AFTER PLANTING AND
- 3. WATER BY FLOODING TWICE IN FIRST TWO HOURS AFTER PLANTING. WATER & MAINTAIN AS PER



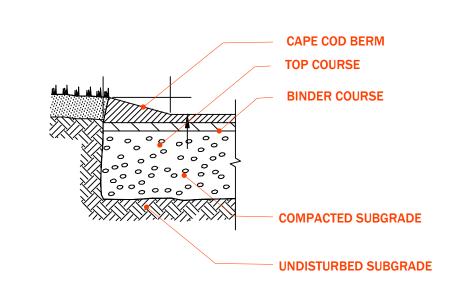



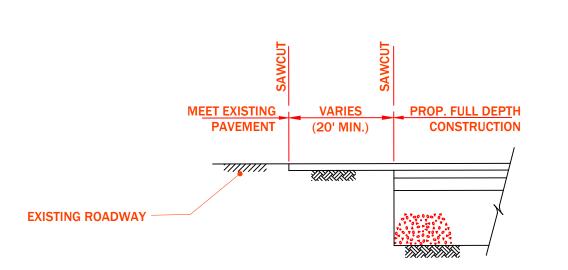





WATER BY FLOODING TWICE IN FIRST TWO HOURS

3 X ROOTBALL


SPACING VARIES
-SEE PLANS

1. LOOSE OR CRACKED ROOTBALLS WILL NOT BE ACCEPTED FOR PLANTING


2. AGED PINE BARK MULCH SHALL BE INSTALLED WITHIN THE LIMITS OF THE ISLAND.

3. PLANTS SHALL BE LOCATED A MINIMUM OF 3 FEET FROM FACE OF PROPOSED CURB.

PLANTING ON SLOPE

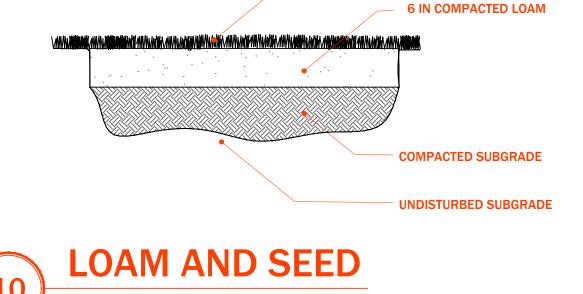

SEED, SEE SPEC FOR MIX

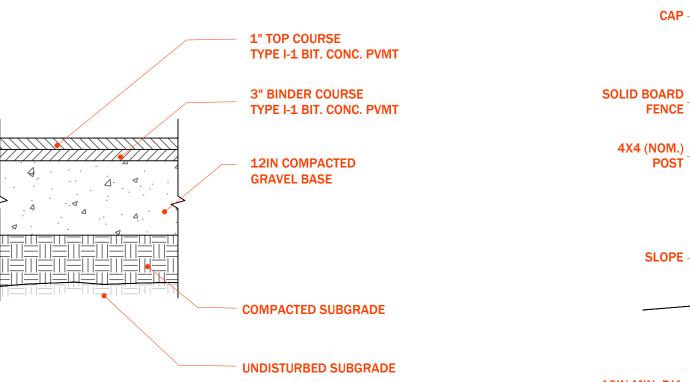

ADJUST SHRUBS SO THAT BOTTOM

3 INCH HIGH EARTH WATERING SAUCER

COMPLETELY REMOVE SYNTHETIC BURLAP AND

LACING. FOR CONTAINERIZED PLANTS, REMOVE

CONTAINER PRIOR TO PLANTING. SCORE SIDES OF ROOT BALL AND LOOSEN ANY ROOTS ENCIRCLING


OF FOLIAGE IS EVENLY SPACED ABOVE THE GROUND

2-3 INCH DEPTH AGED PINE BARK MULCH (PULL AWAY FROM BASE OF SHRUB)

AROUND SHRUB PIT

THE ROOT BALL

UNDISTURBED SUBGRADE

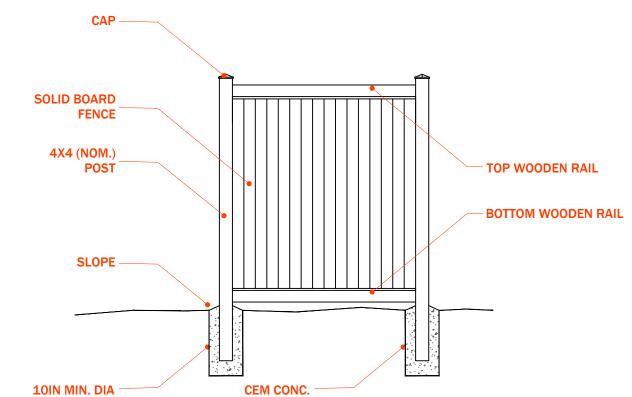


- 1. INSTALLATION TO BE COMPLETED IN ACCORDANCE WITH MANUFACTURER'S SPECIFICATIONS.
- 2. LINE POSTS TO BE SPACED AT 8FT. O.C. UNLESS OTHERWISE NOTED.







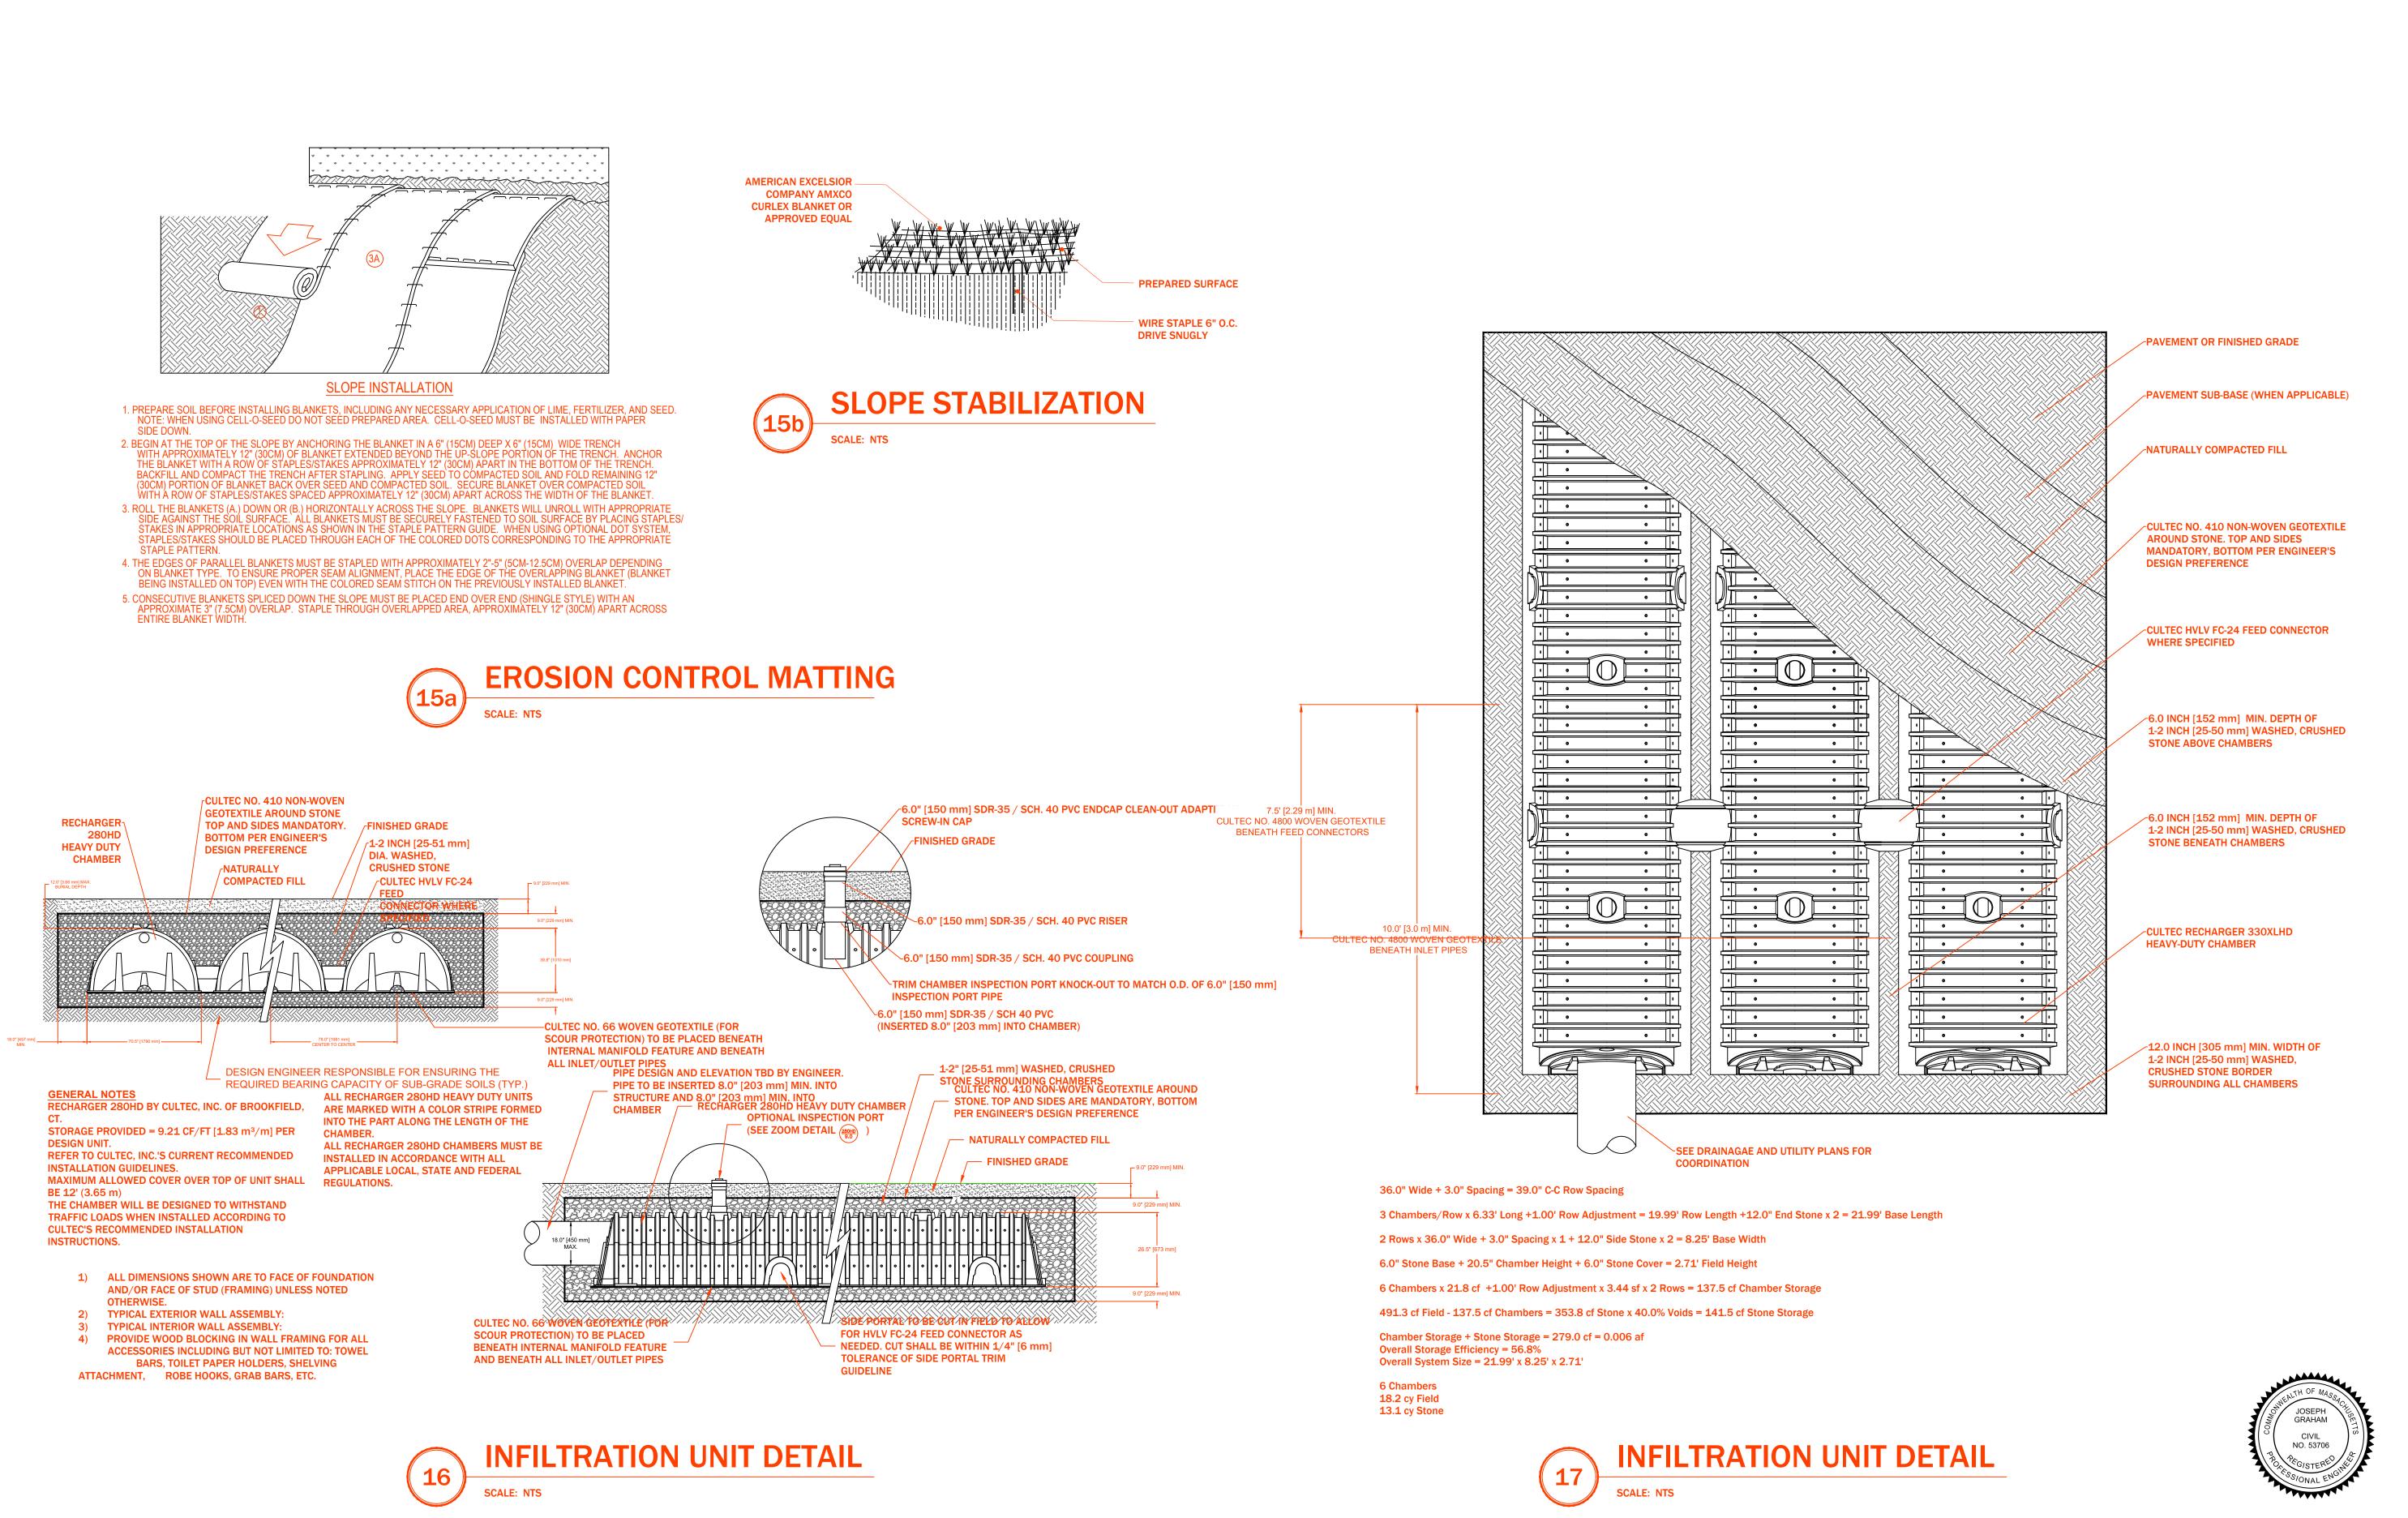

0 BOARD REVIEW 7/4/24

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DESIGNED BY JRG
DRAWN BY JRG
CHECKED BY JRG

SITE PLAN

DRAWING 2NDO

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 DRAWING2MP012 - CONST. DETAIL


 SCALE:
 AS NOTED

 PROJECT NO.:
 24012


CONST

C5.3

SHEET **11** OF **11**

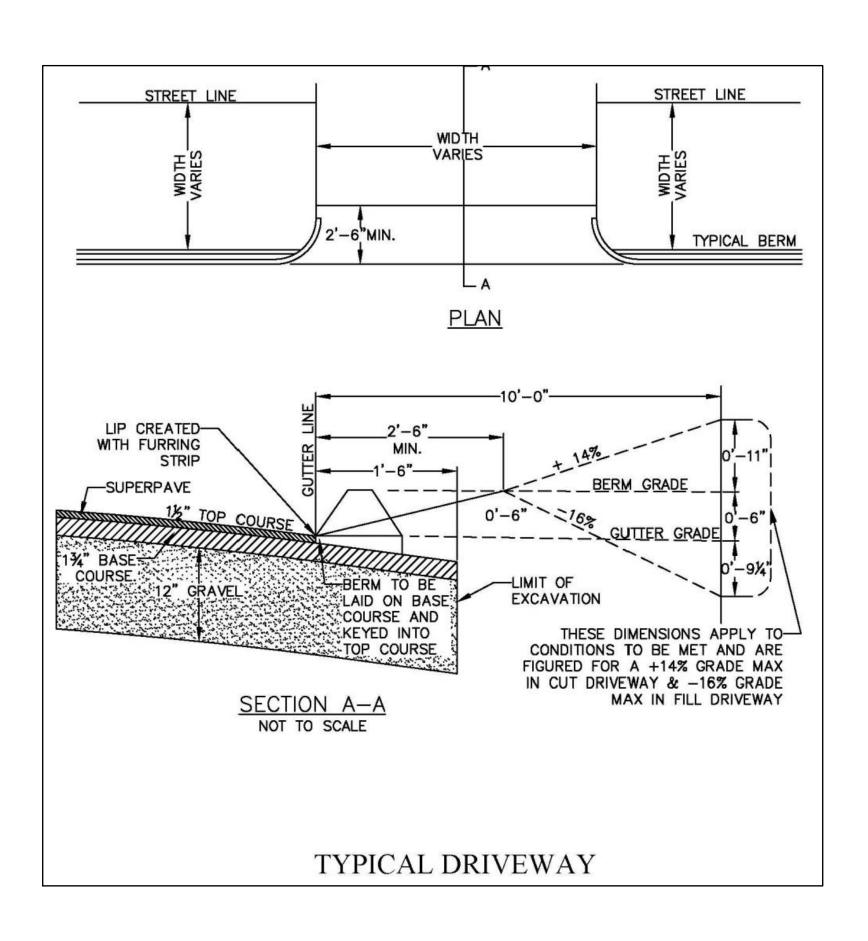



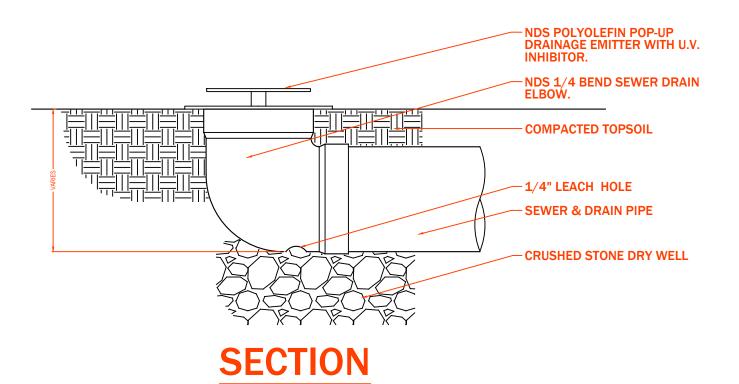

NOTES:

1. INSTALLATION TO BE COMPLETED IN ACCORDANCE WITH MANUFACTURER'S SPECIFICATIONS.

2. DO NOT SCALE DRAWING.

3. THIS DRAWING IS INTENDED FOR USE BY ARCHITECTS, ENGINEERS, CONTRACTORS, CONSULTANTS AND DESIGN PROFESSIONALS FOR PLANNING PURPOSES ONLY.

4. ALL INFORMATION CONTAINED HEREIN WAS CURRENT AT THE TIME OF DEVELOPMENT BUT MUST BE REVIEWED AND APPROVED BY THE PRODUCT MANUFACTURER TO BE CONSIDERED ACCURATE.





FADHEL

DESIGNED BY JRG
DRAWN BY JRG
CHECKED BY JRG

BROOKLINE

RAWING 24012 - CONST. DETAIL

SHEET **12** OF **11**